




PENLAND HALL RESTROOM RENOVATIONS
471 UNIVERSITY PARKWAY
AIKEN, SOUTH CAROLINA
FOR
UNIVERSITY OF SOUTH CAROLINA - AIKEN



- GENERAL NOTES
1. THE GENERAL CONTRACTOR AND HIS SUB-CONTRACTORS SHALL BE REQUIRED TO VISIT THE PREMISES TO INSPECT EXISTING CONDITIONS, BECOME FAMILIAR WITH LOCAL CONDITIONS UNDER WHICH THE WORK IS TO BE PERFORMED AND CORRELATE PERSONAL OBSERVATIONS WITH REQUIREMENTS OF THE DRAWINGS.
 2. ALL WORK PERFORMED SHALL BE IN STRICT COMPLIANCE WITH LOCAL CITY/COUNTY REGULATIONS AND CODES, O.S.H.A. STANDARDS, THE CODE STANDARDS LISTED BELOW, EXECUTED IN ACCORDANCE WITH ACCEPTED INDUSTRY STANDARDS, AND CONFORM TO SPECIFIC REGULATIONS AS MANDATED BY THE OWNER AND THE ARCHITECT.
 3. IT SHALL BE THE GENERAL CONTRACTOR'S RESPONSIBILITY TO INSURE THE PROCUREMENT OF ALL REQUIRED AND NECESSARY PERMITS. ALL CONTRACTORS SHALL OBTAIN NECESSARY AND APPLICABLE, CITY/COUNTY & STATE PERMITS, INSPECTIONS AND APPROVAL PRIOR TO THE COMMENCEMENT OF ANY WORK AND CERTIFICATE OF OCCUPANCY UPON COMPLETION OF PROJECT. CONTRACTOR SHALL FURNISH COPIES OF PERMITS, INSPECTIONS AND CERTIFICATES TO OWNER UPON REQUEST.
 4. CONTRACTOR SHALL BE REQUIRED TO COORDINATE WORK SCHEDULE TO MINIMIZE DISRUPTION OF NORMAL ACTIVITIES AND TO AVOID INTERFERENCE WITH ADJACENT OPERATIONS. THE CONTRACTOR SHALL BE RESPONSIBLE FOR TAKING ADEQUATE PRECAUTIONS TO PROTECT SURROUNDINGS, MATERIALS AND EXISTING FINISHES THROUGHOUT ALL PHASES OF CONSTRUCTION AREAS AND OCCUPIED OR PUBLIC AREAS TO BE MAINTAINED BY CONTRACTOR. DAMAGE TO EXISTING-TO-REMAIN CONSTRUCTION, MATERIALS OR EQUIPMENT TO BE RESTORED TO ORIGINAL CONDITION.
 5. CONTRACTOR SHALL BE RESPONSIBLE FOR REMOVAL OF TRASH AND DEBRIS FROM JOB SITE ON A DAILY BASIS. FINAL CLEAN-UP WITHIN SCOPE OF WORK. REMOVE DUST, DEBRIS, OILS, STAINS, FINGERPRINTS AND LABELS FROM ALL EXPOSED FINISHED SURFACES.
 6. GENERAL CONTRACTOR SHALL BE RESPONSIBLE FOR THE COORDINATION OF ALL RELATED TRADES AND VENDORS NECESSARY TO THE COMPLETION OF THE JOB ON A TIMELY BASIS.
 7. DO NOT SCALE DRAWINGS. USE WRITTEN DIMENSIONS ONLY. SUBMIT TO ARCHITECT ANY DISCREPANCIES FOR CLARIFICATION.
 8. ALL WORK SHALL BE IN COMPLIANCE WITH THE INTERNATIONAL BUILDING CODE, AIA A-201 GENERAL CONDITIONS OF THE CONTRACT FOR CONSTRUCTION, CURRENT EDITION OF NATIONAL ELECTRIC CODE, INTERNATIONAL PLUMBING, MECHANICAL, AND ELECTRICAL CODE, RECOGNIZED INDUSTRY STANDARDS, CRAFTSMANSHIP STANDARDS IN THE AREA, ALL MANUFACTURERS RECOMMENDATIONS, AND ALL OTHER APPLICABLE CODES.
 9. THE ARCHITECT DOES NOT GUARANTEE THE PERFORMANCE OF THE PROJECT IN ANY RESPECT OTHER THAN THAT OUR ARCHITECTURAL WORK AND JUDGEMENT RENDERED MEET THE STANDARDS OF CARE OF OUR PROFESSION.
 10. PROVIDE ACCESSIBILITY FOR THE PHYSICALLY HANDICAPPED CONFORMING TO THE CURRENT EDITION OF ADA GUIDELINES, AND ANSI 117.1
 11. THE LOCATION OF THE EXISTING UTILITIES AND STRUCTURES SHOWN HEREON ARE APPROXIMATE. IT SHALL BE THE RESPONSIBILITY OF THE CONTRACTOR TO VERIFY THE EXISTENCE AND ACTUAL LOCATION OF SUCH, WHETHER SHOWN HEREON OR NOT, PRIOR TO ANY EXCAVATION, ANY DAMAGES SHALL BE REPAIRED AT THE EXPENSE OF THE CONTRACTOR.
 12. THE FLOOR ON BOTH SIDES OF A DOOR SHALL BE LEVEL AND SHALL HAVE THE SAME ELEVATION ON BOTH SIDES OF THE DOOR, FOR A DISTANCE ON EACH SIDE EQUAL TO THE WIDTH OF THE WIDEST SINGLE DOOR.
 13. EVERY INTERIOR AND EXTERIOR DOOR IN THE BUILDING SHALL BE PROVIDED WITH HANDICAP HARDWARE (LEVERS, PUSH-BUTTONS, OR U-SHAPED HANDLES, ETC.) TO MEET ACCESSIBILITY GUIDELINES AND ANSI 117.1. THE CONTRACTOR SHALL PROVIDE ADEQUATE BRACING AND SHORING FOR ALL WORK DURING THE CONSTRUCTION PERIOD.
 14. ALL EXIT DOORS AND DOORS IN THE MEANS OF EGRESS SHALL BE SIDE HINGED AND SWING IN THE DIRECTION OF EXIT TRAVEL AND IF ANY LOCKING OR LATCHING DEVICE IS TO BE PROVIDED, ONLY APPROVED HARDWARE MAY BE USED.
 15. SMOKE DETECTORS AND FIRE EXTINGUISHERS ARE TO BE INSTALLED PER THE REQUIREMENTS OF THE OCCUPANCY CHAPTER OF NFPA 101 LIFE SAFETY CODE.
 16. ALL NOTES AND REFERENCES FOR ONE SECTION OR DETAIL APPLY TO ALL OTHERS WHEN LIKE OR SIMILAR CONDITIONS ARE EVIDENT.
 17. ALL WOOD BLOCKING, PLYWOOD AND NAILERS SHALL BE PRESSURE TREATED, TYPICAL.
 18. PREVENT CONTACT OF DISSIMILAR METALS BY PROVIDING AN AIR SPACE OR PHYSICAL BARRIER (i.e. 15# FELT).
 19. PROVIDE CONT. CAULKING OR SEALANT IN CONTROL AND CONSTRUCTION JOINTS, AROUND PERIMETER OF METAL DOOR FRAMES, WHERE DISSIMILAR MATERIALS ABUT AND WHEREVER THE POTENTIAL FOR AIR OR MOISTURE INFILTRATION EXISTS. PROVIDE BACKER RODS WHERE SHOWN OR REQUIRED. FOLLOW ALL MANUFACTURER'S INSTRUCTIONS FOR SURFACE PREPARATION AND APPLICATION. COLORS SHALL MATCH ADJACENT FINISHES.
 20. PROVIDE CONT. BLOCKING, AS REQUIRED, IN WALLS TO RECEIVE ACCESSORY ITEMS INCLUDING BUT NOT LIMITED TO THE FOLLOWING:
HANDRAILS
TOILET ROOM ACCESSORIES
GRAB BARS
FIRE EXTINGUISHER CABINETS & BRACKETS
 21. CLEAN WALLS, DOORS, DOOR FRAMES, HANDRAILS, GUARDRAILS, ETC. PER MANUFACTURERS RECOMMENDATIONS PRIOR TO SEALING AND PAINTING.
 22. VERIFY MEASUREMENTS WITH CORRESPONDING CONSTRUCTED OR EXISTING CONDITIONS PRIOR TO PROCEEDING WITH THE WORK AND NOTIFY THE ARCHITECT IMMEDIATELY OF SIGNIFICANT DISCREPANCIES USING THE "CONSTRUCTION REQUEST FOR INFORMATION" FORM. PROVIDE SUPPLEMENTARY CONTRACTOR DETAILS AS REQUIRED.
 23. CONCRETE TEST REPORTS SHALL BE AVAILABLE AT JOB SITE AT ALL TIMES.

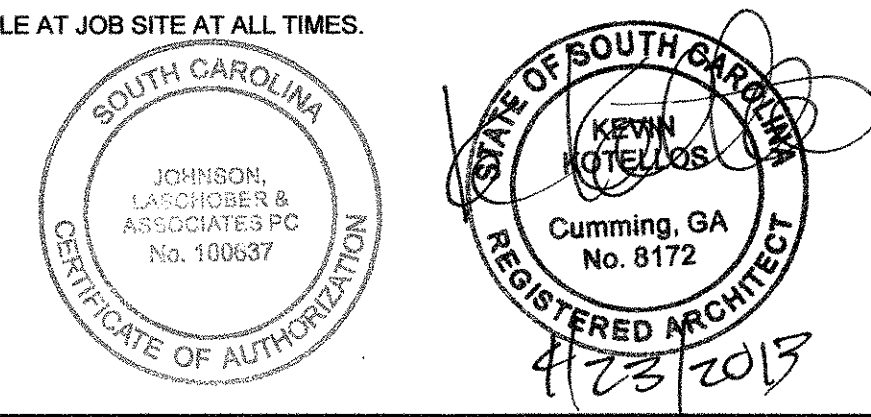

SET CONTENTS

SHEET INDEX	
Sheet Number	Sheet Title
G001	COVER SHEET
A100	FIRST FLOOR RESTROOM PLANS
A101	SECOND FLOOR RESTROOM PLANS
A102	PHOTOGRAPHS OF EXISTING
A200	INTERIOR ELEVATIONS
A201	INTERIOR ELEVATIONS
A401	ADA DETAILS
P100	FIRST FLOOR PLUMBING PLANS
P101	SECOND FLOOR PLUMBING PLANS
P200	PLUMBING SCHEDULES, NOTES AND DETAILS
E100	ELECTRICAL OVERALL PLAN
E101	ELECTRICAL FIRST FLOOR PLAN
E102	ELECTRICAL SECOND FLOOR PLAN

SCOPE OF WORK IN THIS CONTRACT SHALL INCLUDE FIRST FLOOR RESTROOM RENOVATIONS IN BASE BID. PROVIDE ADD ALTERNATE #1 FOR SECOND FLOOR RESTROOM RENOVATIONS

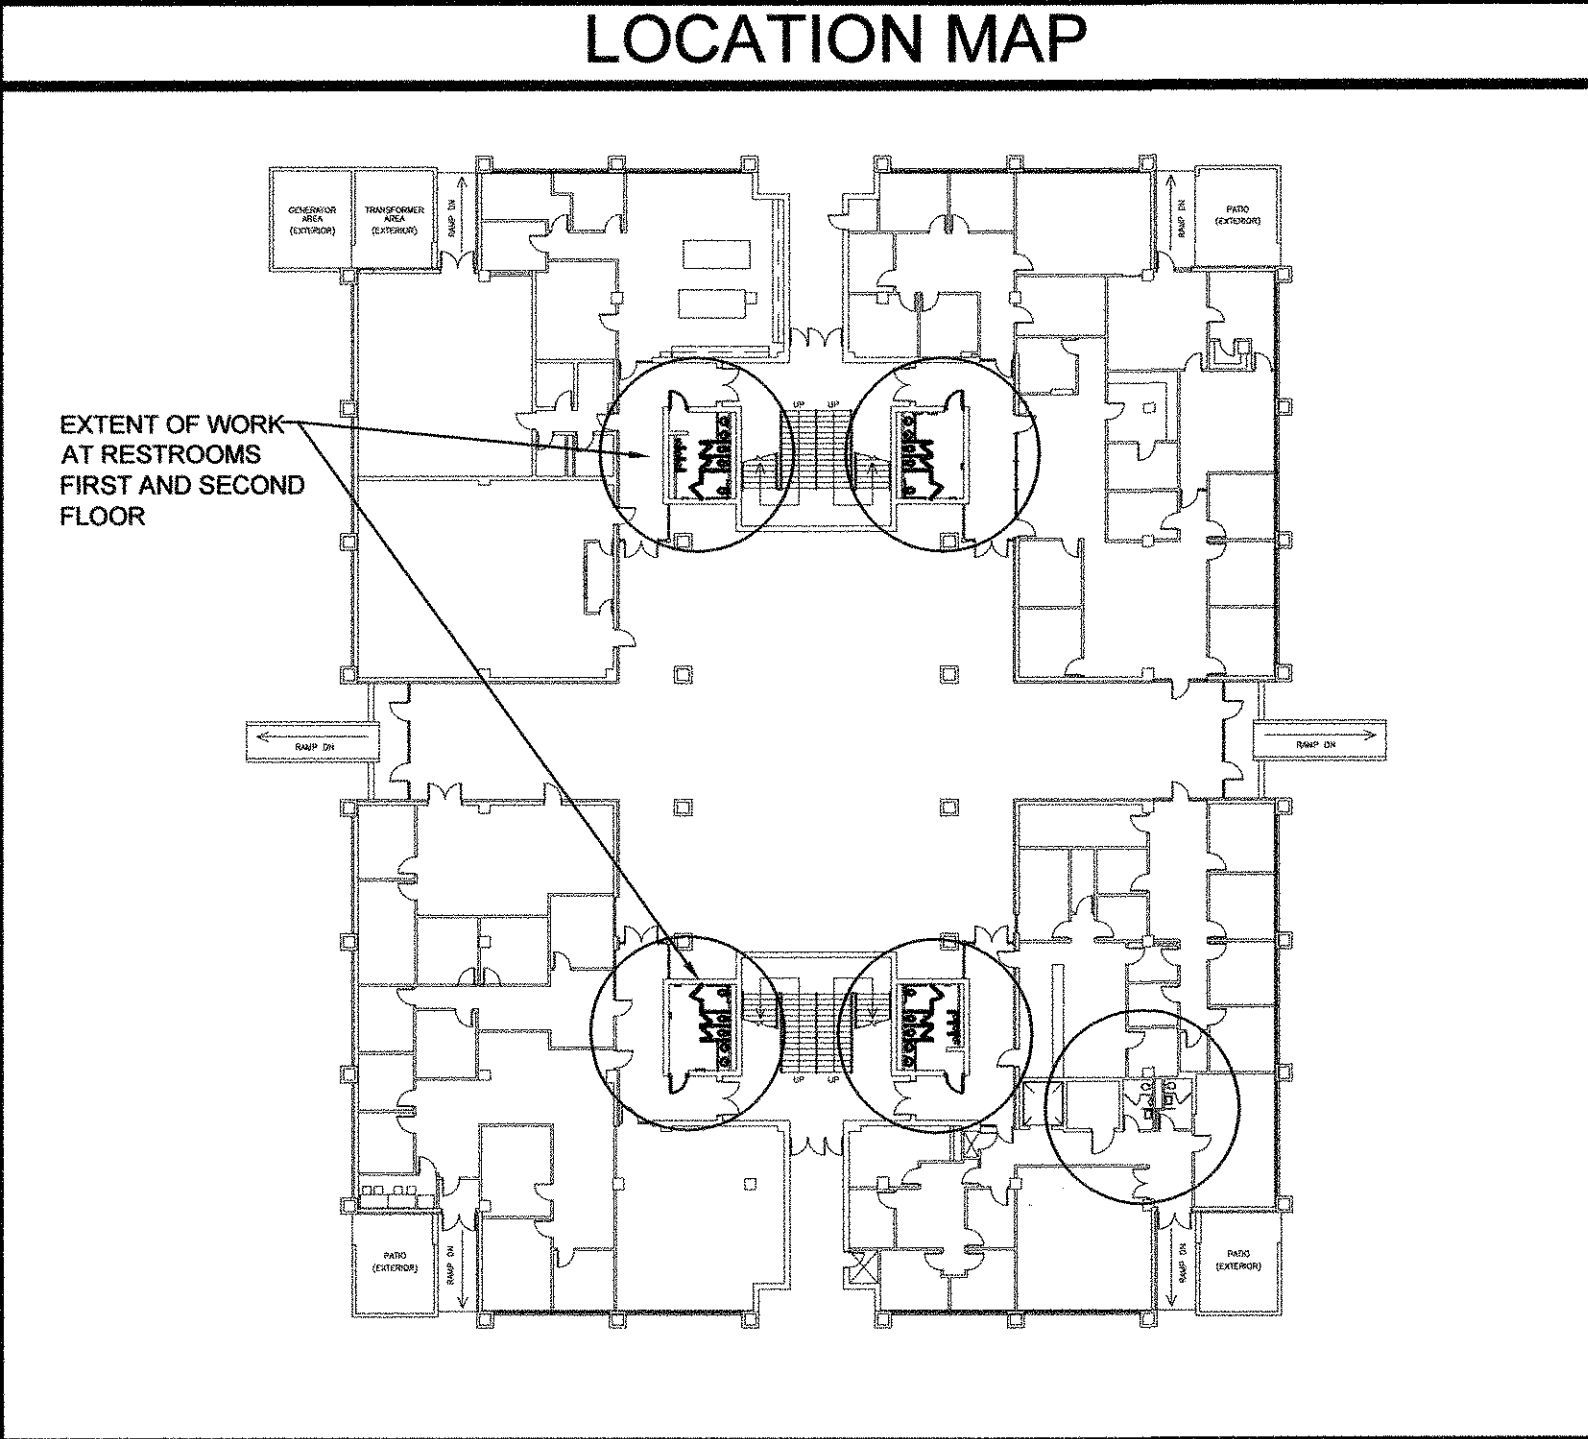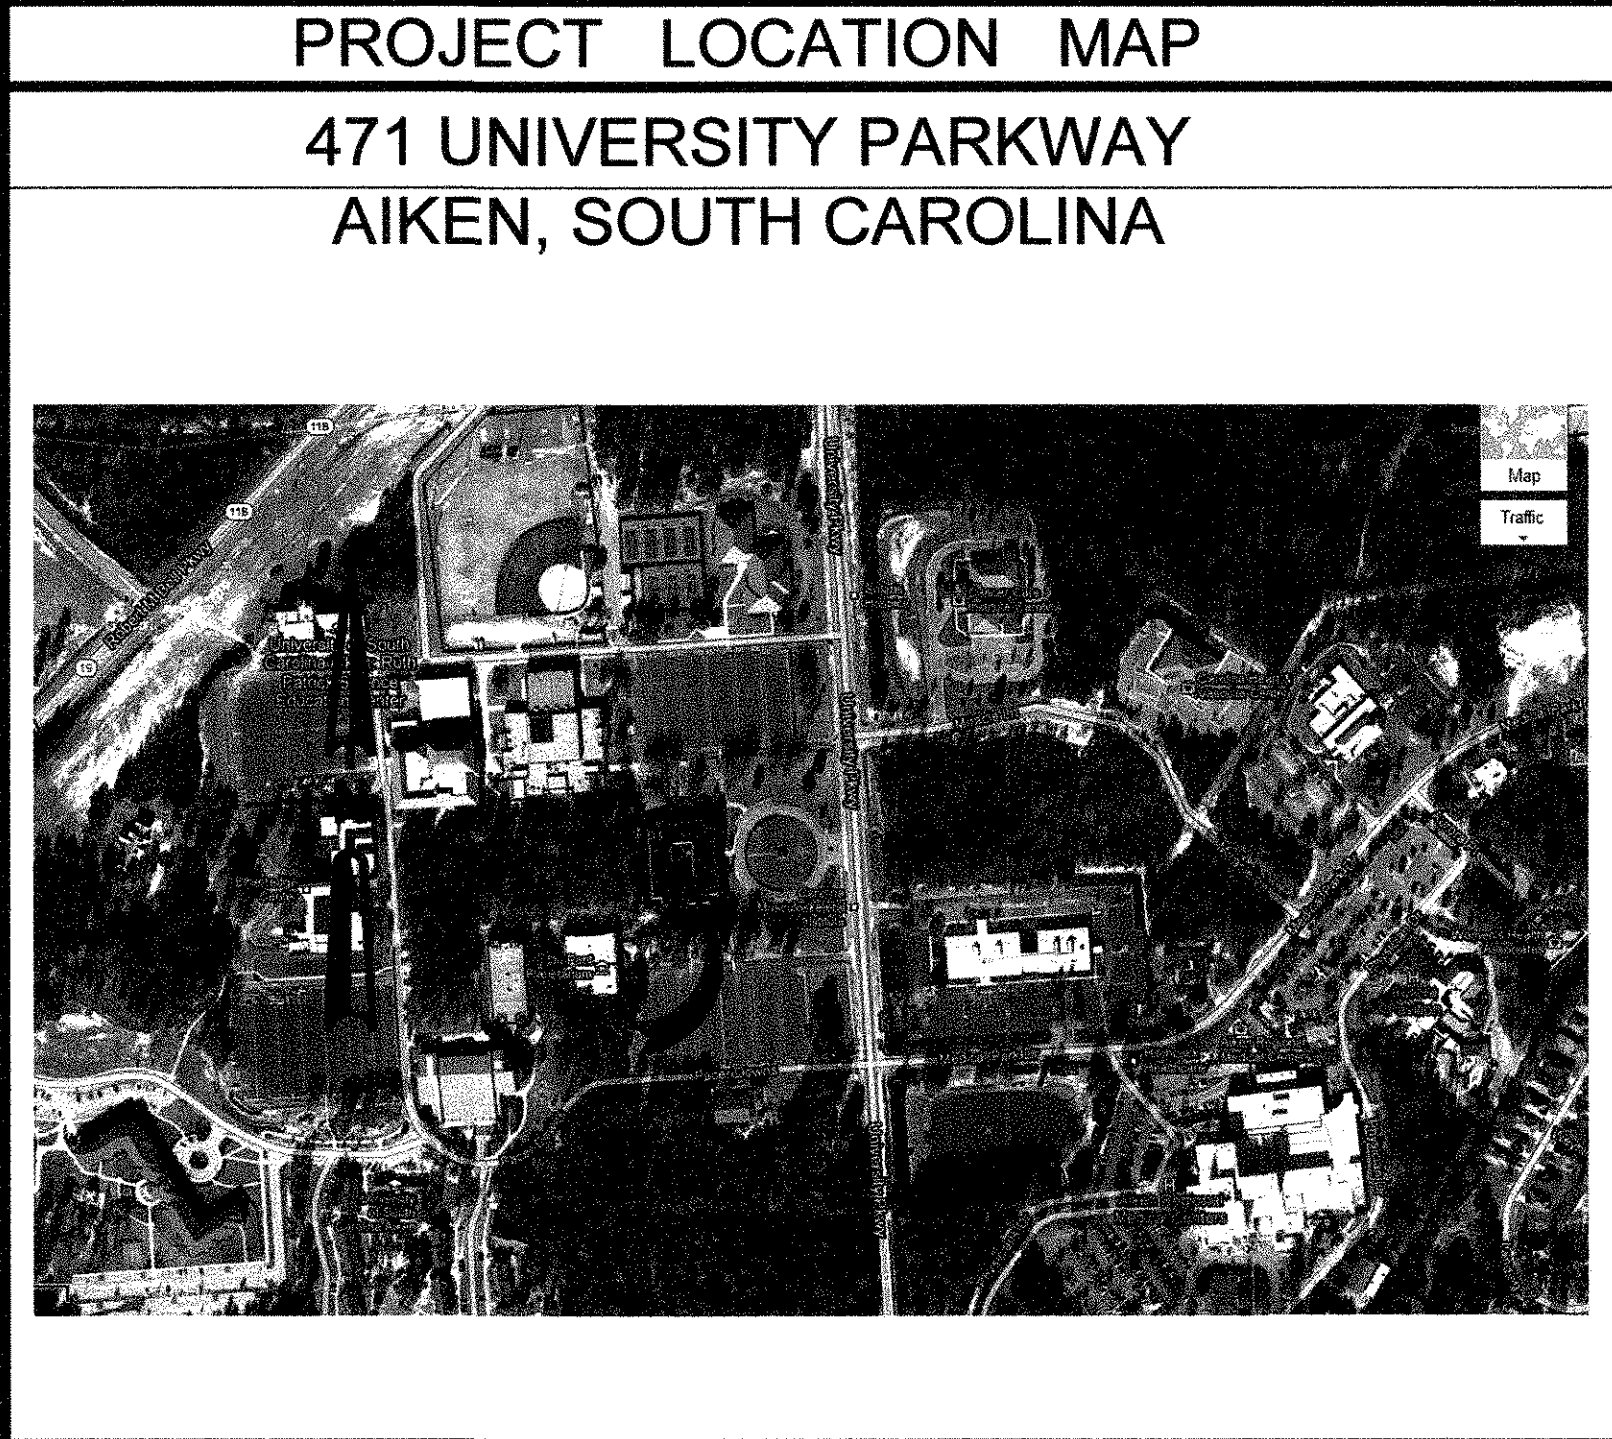

PROJECT TEAM

OWNER:
UNIVERSITY OF SOUTH CAROLINA - AIKEN
471 UNIVERSITY PARKWAY
AIKEN, SOUTH CAROLINA
LISA GROFT, PROJECT MANAGER
PHONE: (803) 641-2856
EMAIL: LisaG@usca.edu

ARCHITECT/ENGINEER PRIMARY CONTACT:
JOHNSON LASCHOB & ASSOCIATES, P.C.
DARREN PRICKETT, REGISTERED LANDSCAPE ARCHITECT
1296 BROAD ST.
AUGUSTA, GA. 30901
PHONE: (706) 724-5756
EMAIL: Ddprickett@thejlagroup.com

ARCHITECT:
JOHNSON LASCHOB & ASSOCIATES, P.C.
KEVIN KOTELLOS, REGISTERED ARCHITECT
1296 BROAD ST.
AUGUSTA, GA. 30901
PHONE: (706) 724-5756
EMAIL: kkotellos@thejlagroup.com

STRUCTURAL ENGINEER:
JOHNSON LASCHOB & ASSOCIATES, P.C.
DONALD THORSTAD, PE
1296 BROAD ST.
AUGUSTA, GA. 30901
PHONE: (706) 724-5756
EMAIL: dthorstad@thejlagroup.com

MECHANICAL ENGINEER:
JOHNSON LASCHOB & ASSOCIATES, P.C.
CURTIS WILLIAMSON, PE
1296 BROAD ST.
AUGUSTA, GA. 30901
PHONE: (706) 724-5756
EMAIL: cwilliamson@thejlagroup.com

ELECTRICAL ENGINEER:
JOHNSON LASCHOB & ASSOCIATES, P.C.
RALPH SALZMANN, PE
1296 BROAD ST.
AUGUSTA, GA. 30901
PHONE: (706) 724-5756
EMAIL: rsalzmann@thejlagroup.com

CODE DATA

APPLICABLE CODES

- IBC (INTERNATIONAL BUILDING CODE), 2006 EDITION
- IFGC (INTERNATIONAL FUEL GAS CODE), 2006 EDITION
- IMC (INTERNATIONAL MECHANICAL CODE), 2006 EDITION
- IPC (INTERNATIONAL PLUMBING CODE), 2006 EDITION
- NATIONAL ELECTRICAL CODE, 2008 EDITION
- INTERNATIONAL FIRE CODE, 2006 EDITION
- IECC, 2006 EDITION
- NFPA 101 LIFE SAFETY CODES, 2000 EDITION
- CURRENT EDITION OF ADA GUIDELINES
- ANSI 117.1

TYPE OF CONSTRUCTION 2006 IBC-SECTION 602
2B UNSPRINKLERED

OCCUPANCY TYPE: 2006 IBC-SECTION 303
BUSINESS OCCUPANCY

SCOPE OF WORK:
SELECTIVE DEMOLITION OF EXISTING FIRST AND SECOND FLOOR RESTROOMS. NEW CONSTRUCTION AND RENOVATION OF EXISTING RESTROOMS AT FIRST AND SECOND FLOOR. NO CHANGE IN OCCUPANCY, LIFE SAFETY REQUIREMENTS, OR CODE RELATED ISSUES.

SOIL TREATMENT:
TERMITICIDE: PROVIDE AN EPA-REGISTERED TERMITICIDE, COMPLYING WITH REQUIREMENTS OF AUTHORITIES HAVING JURISDICTION, IN AN AQUEOUS SOLUTION FORMULATED TO PREVENT TERMITE INFESTATION. PROVIDE QUANTITY REQUIRED FOR APPLICATION AT THE LABEL VOLUME AND RATE FOR THE MAXIMUM TERMITICIDE CONCENTRATION ALLOWED FOR EACH SPECIFIC USE, ACCORDING TO PRODUCT'S EPA-REGISTERED LABEL.

PRODUCTS: SUBJECT TO COMPLIANCE WITH REQUIREMENTS, [PROVIDE THE FOLLOWING] (PROVIDE ONE OF THE FOLLOWING) [AVAILABLE PRODUCTS THAT MAY BE INCORPORATED INTO THE WORK INCLUDE, BUT ARE NOT LIMITED TO, THE FOLLOWING:
A. BASF CORPORATION, AGRICULTURAL PRODUCTS; TERMIDOR.
B. BAYER ENVIRONMENTAL SCIENCE; PREMISE 75.
C. FMC CORPORATION, AGRICULTURAL PRODUCTS GROUP; [DRAGNET FT SERVICE LIFE OF TREATMENT: SOIL TREATMENT TERMITICIDE THAT IS EFFECTIVE FOR NOT LESS THAN THREE YEARS AGAINST INFESTATION OF SUBTERRANEAN TERMITES.

PROJECT IDENTification SIGNS
GENERAL CONTRACTOR SHALL BE RESPONSIBLE FOR A MINIMUM OF TWO (2) PROJECT IDENTIFICATION SIGNS 8'-0"x4'-0"
THE SIGNS SHALL BE CONSTRUCTED OF COROPLAST, CORRUGATED PLASTIC, MOUNTED ON A PAINTED 2 X 4 FRAME, AND ATTACHED TO PAINTED 4 X 4 POSTS ANCHORED INTO THE GROUND. SIGNS SHALL BE FRAMED WITH PAINTED WOOD TRIM.

SILKSCREENED GRAPHICS INCLUDE:
USC AIKEN LOGO AND TEXT
JLA LOGO AND TEXT
GENERAL CONTRACTOR LOGO AND TEXT
MASTER PLAN/COLORED SITE PLAN

CONTACT JLA FOR HIGH RESOLUTION GRAPHICS AND SUBMIT TO SIGNAGE COMPANY FOR MOCK UP AND REVIEW PRIOR TO ORDERING SIGNS.

TEMPORARY SIGNS: PROVIDE OTHER SIGNS AS REQUIRED TO INFORM PUBLIC AND INDIVIDUALS SEEKING ENTRANCE TO PROJECT.
PROVIDE TEMPORARY, DIRECTIONAL SIGNS FOR CONSTRUCTION PERSONNEL AND VISITORS. MAINTAIN AND TOUCHUP SIGNS SO THEY ARE LEGIBLE AT ALL TIMES.


JOHNSON, LASCHOB & ASSOCIATES, P.C.

1296 BROAD STREET
TEL: (706) 724-5756


P.O. BOX 2103

AUGUSTA, GEORGIA 30903
FAX: (706) 724-3955


WEBSITE: www.theJLAgroun.com

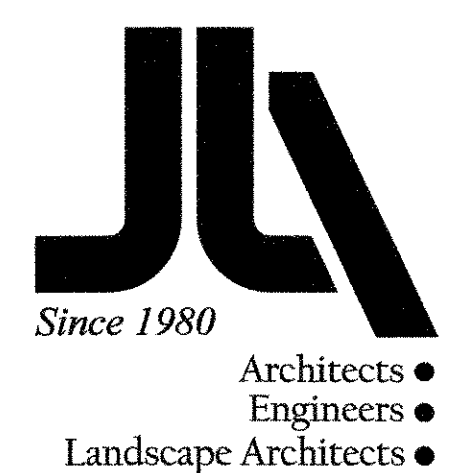


BORDER FILENAME: JLA-Cover-2008.dwg

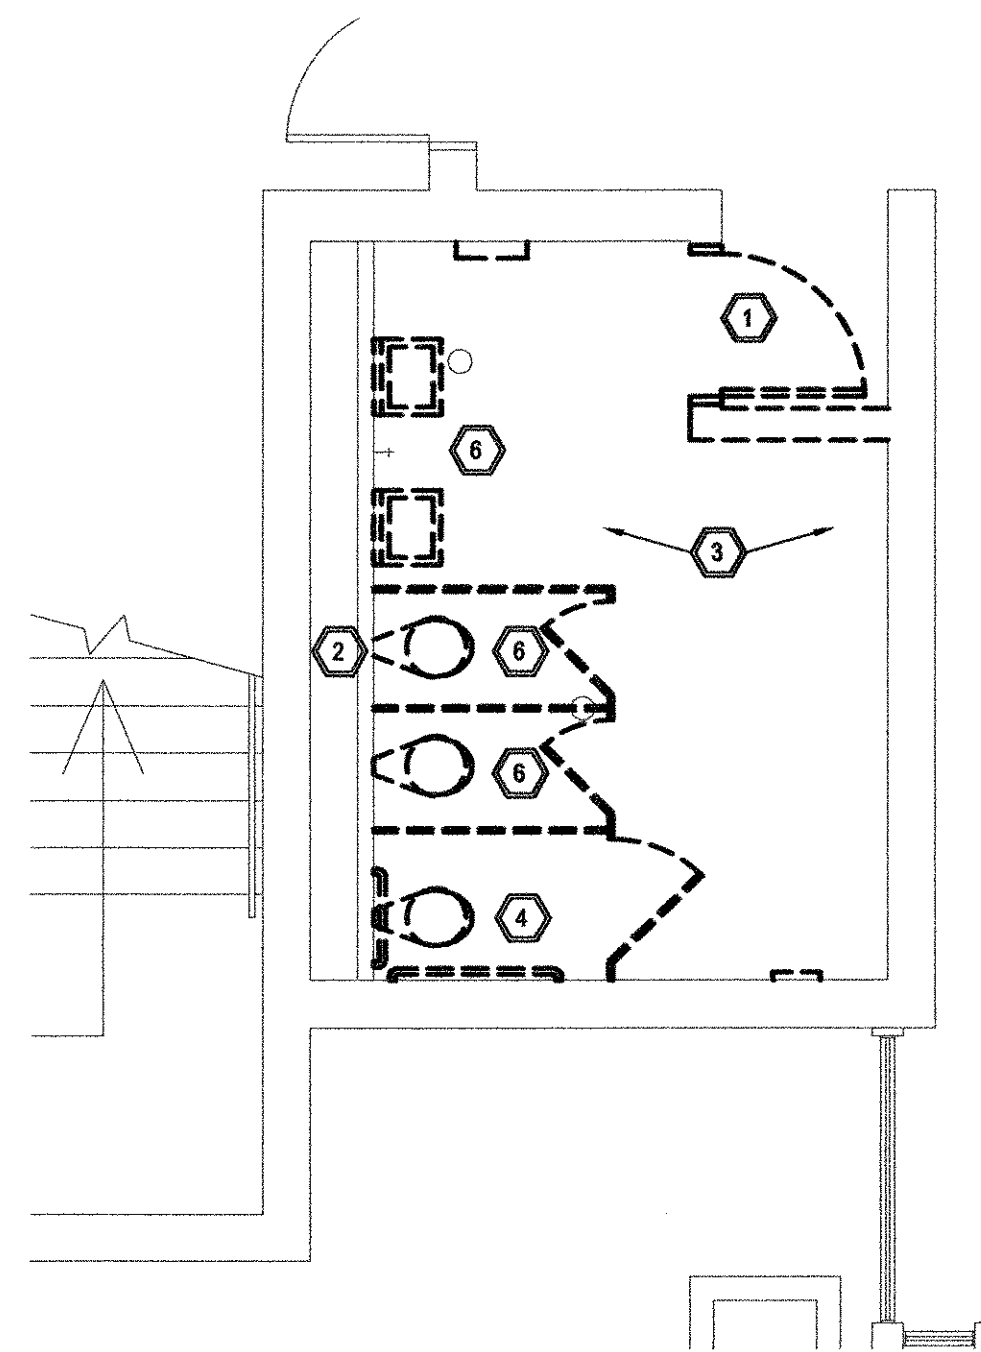


EXISTING / DEMO PLAN

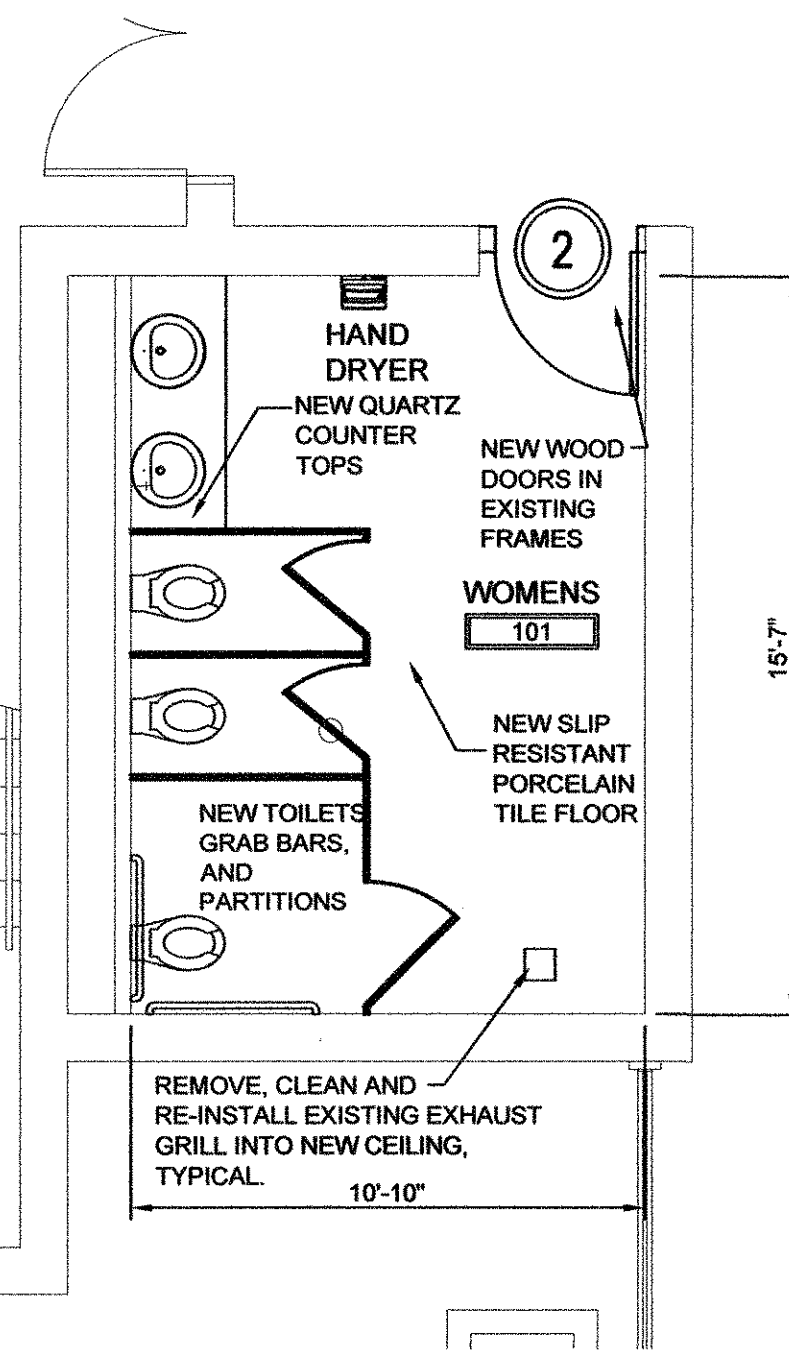


PROPOSED PLAN

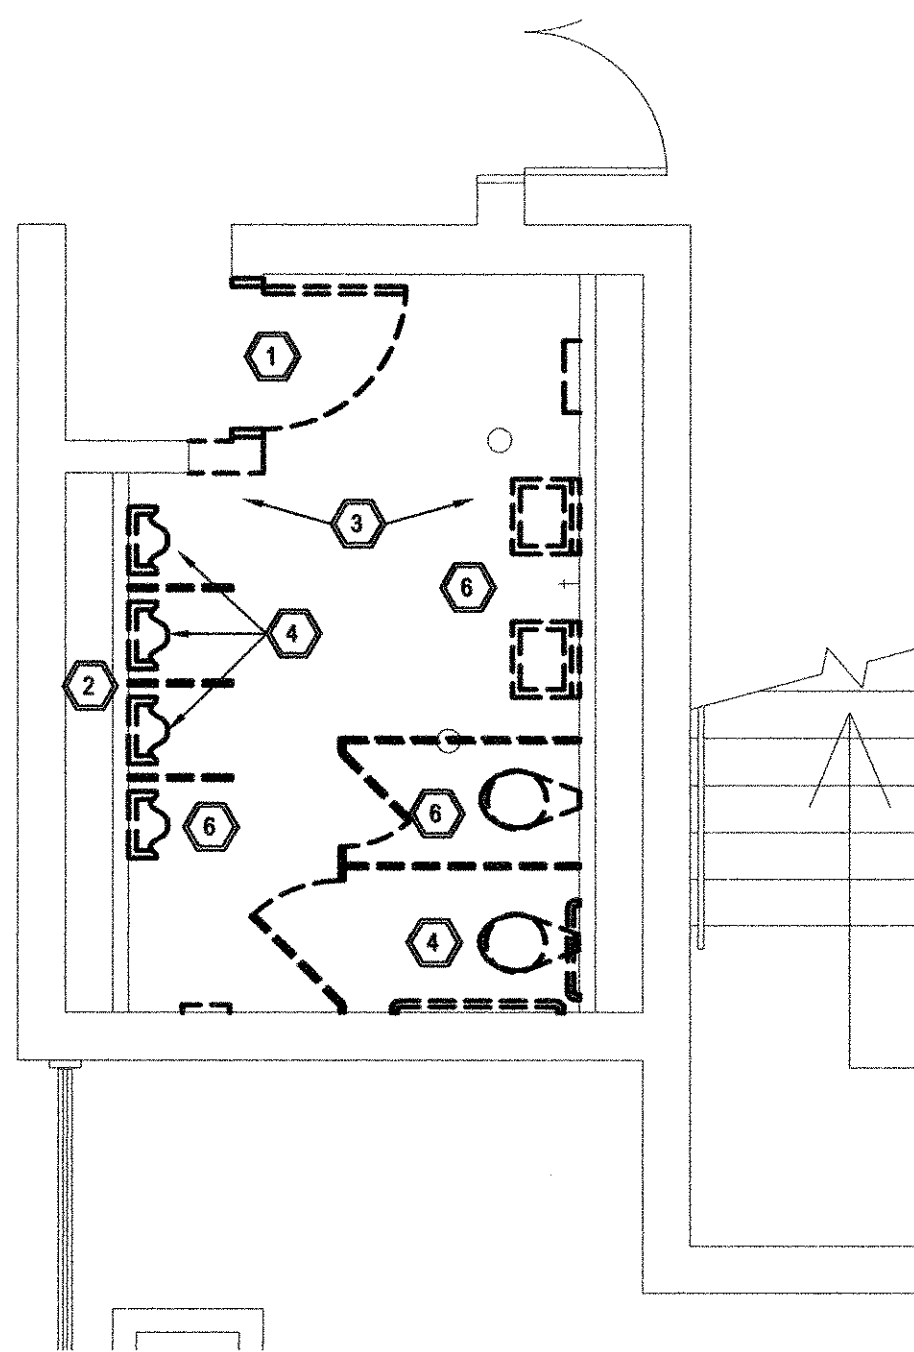


EXISTING / DEMO PLAN

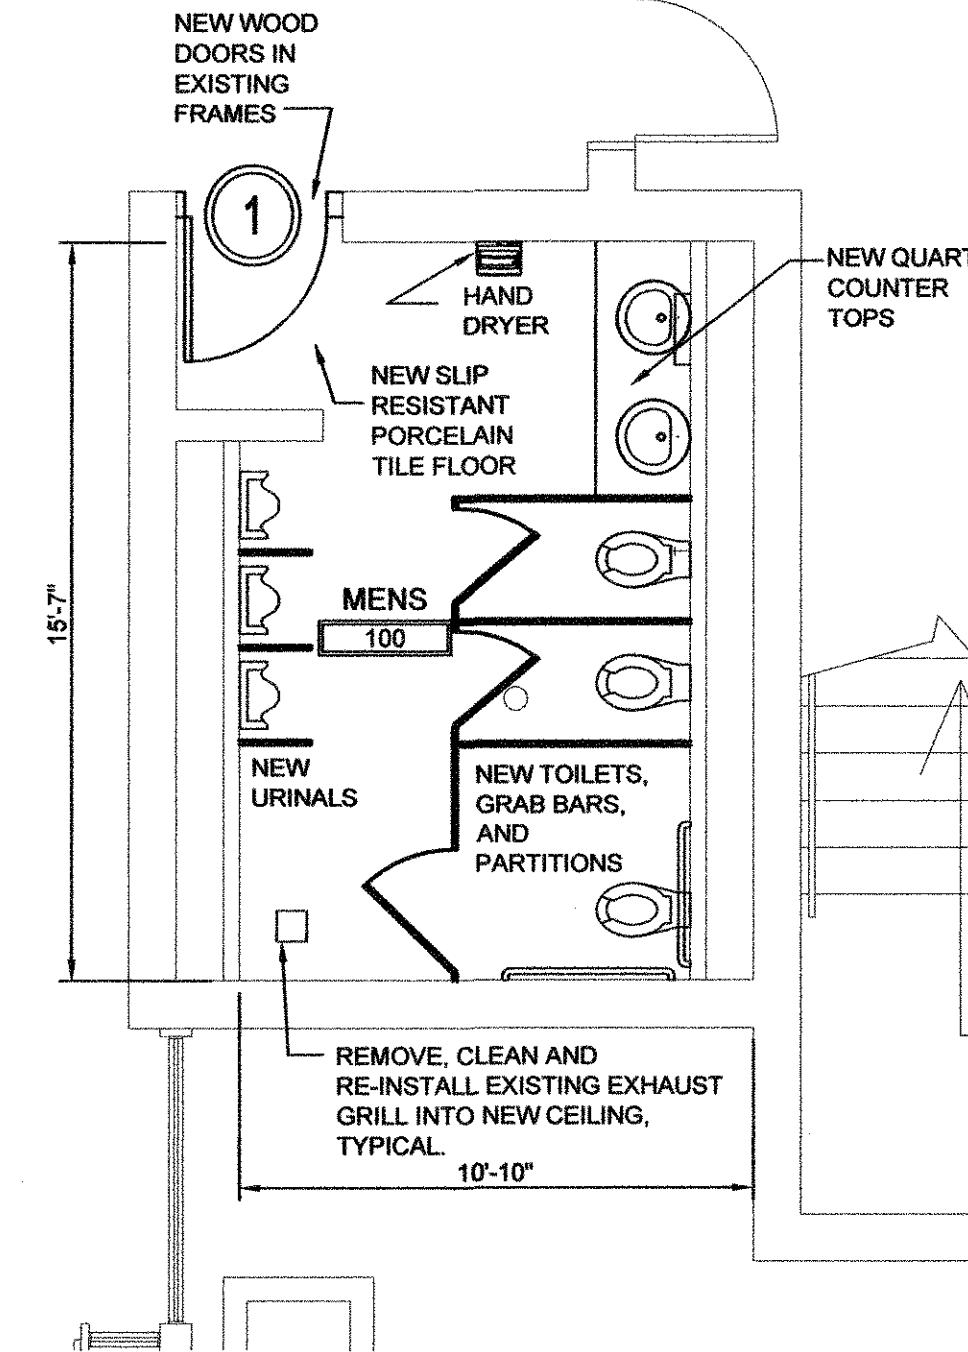

PROPOSED PLAN

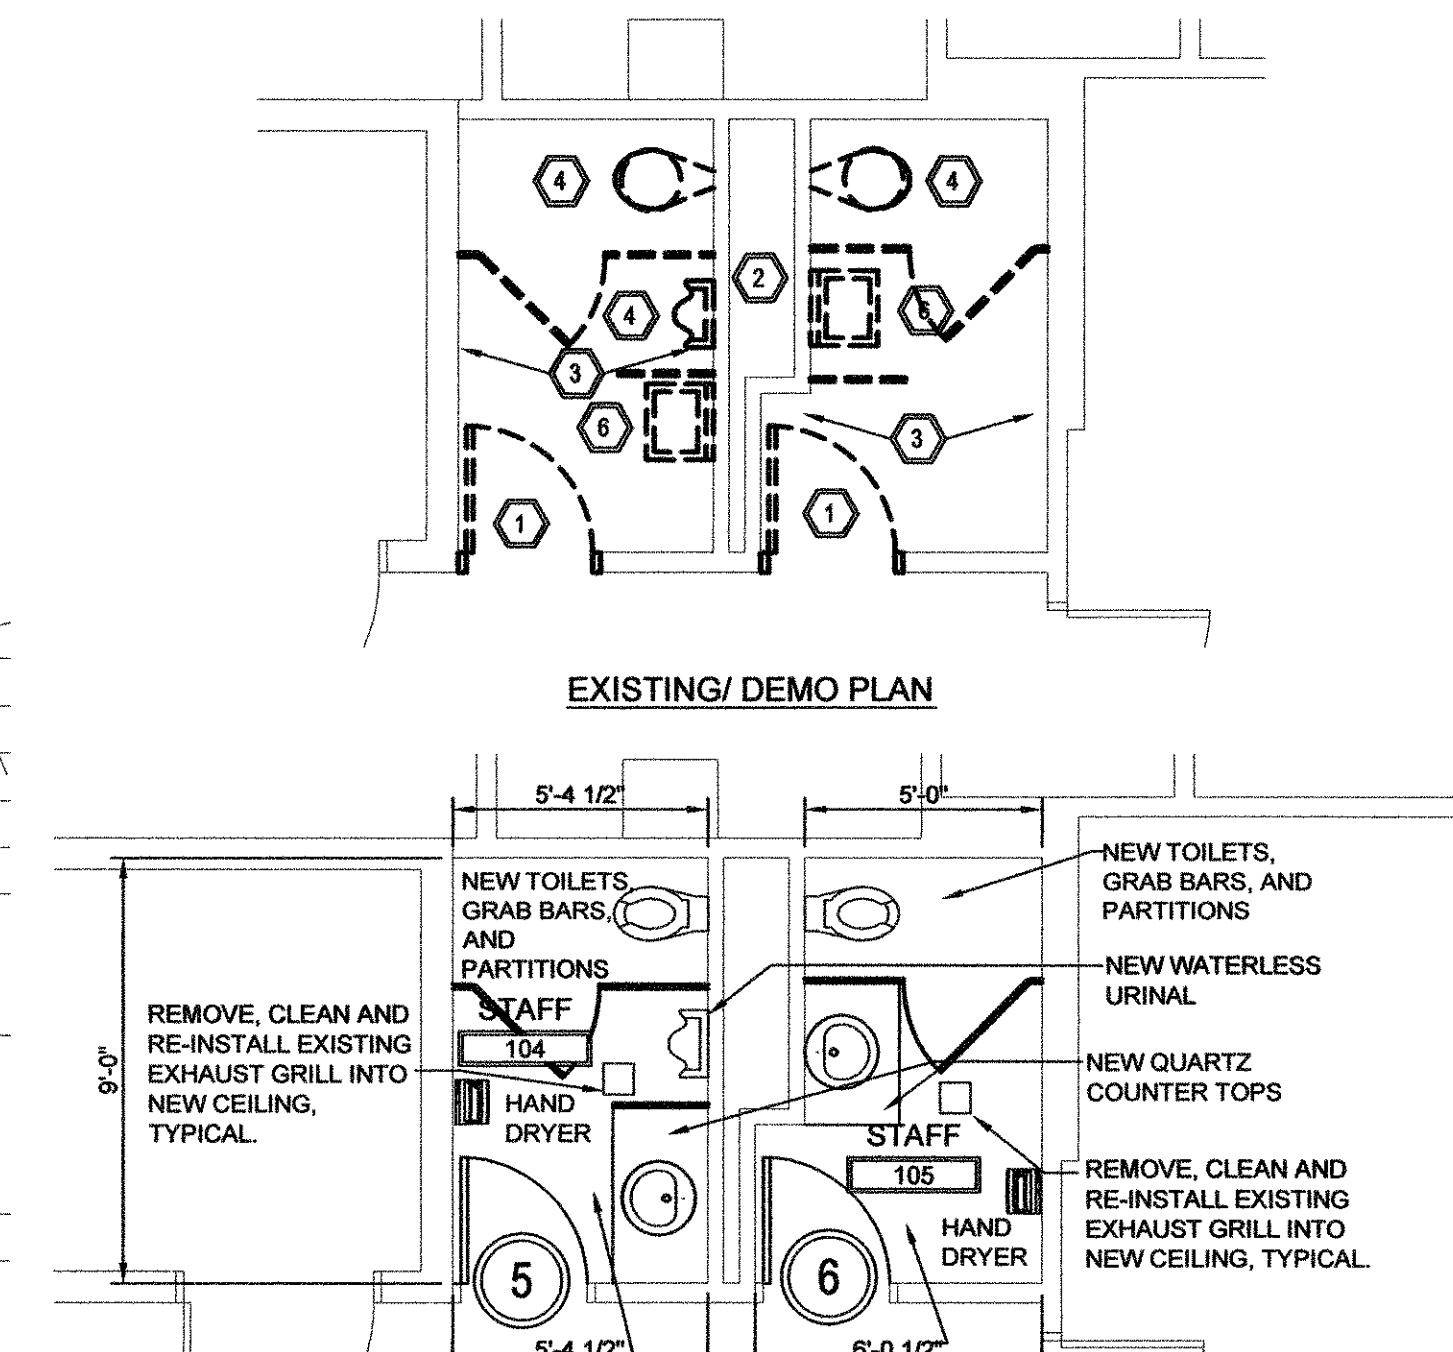

EXISTING / DEMO PLAN

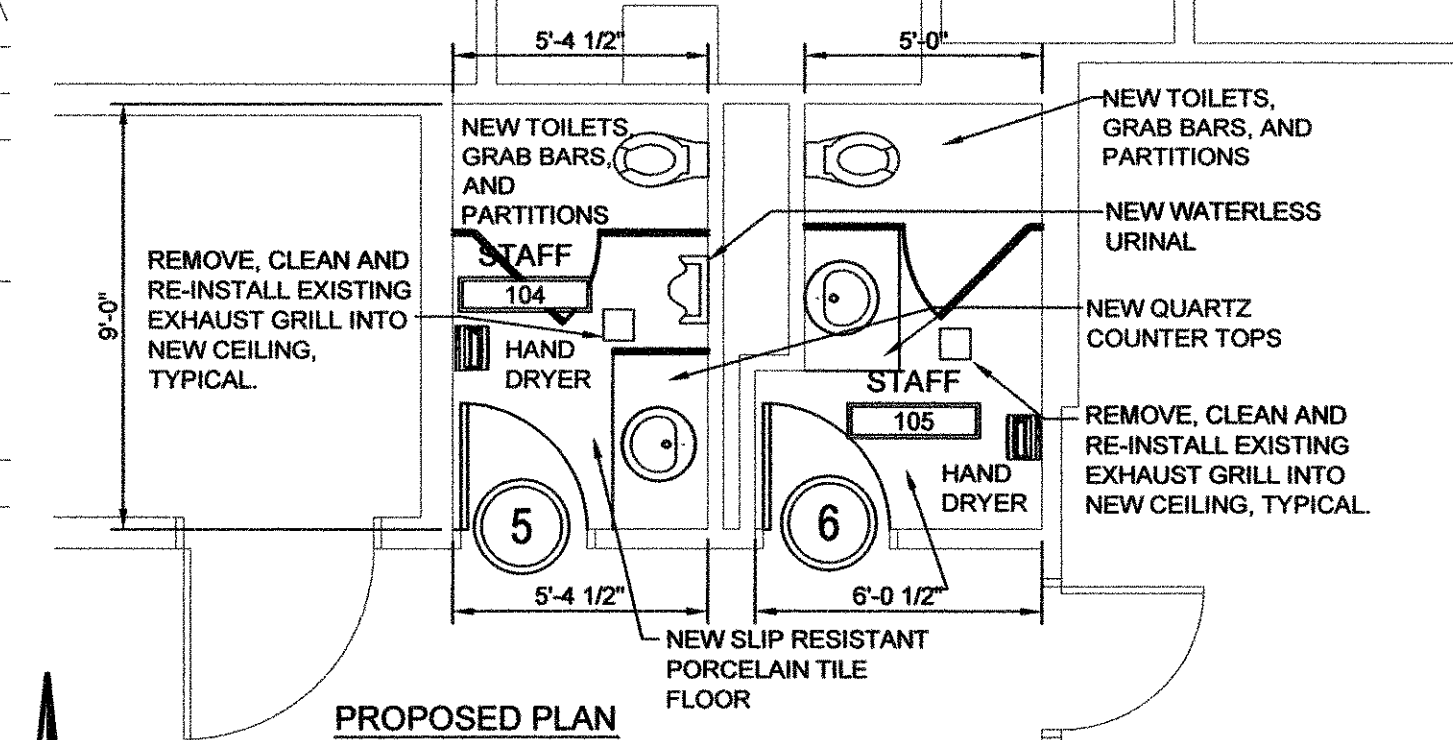


PROPOSED PLAN


1 WOMEN'S TOILET - NORTH
SCALE: 1/4" = 1'-0"

2 MEN'S TOILET - NORTH
SCALE: 1/4" = 1'-0"


3 STAFF TOILET
SCALE: 1/4" = 1'-0"

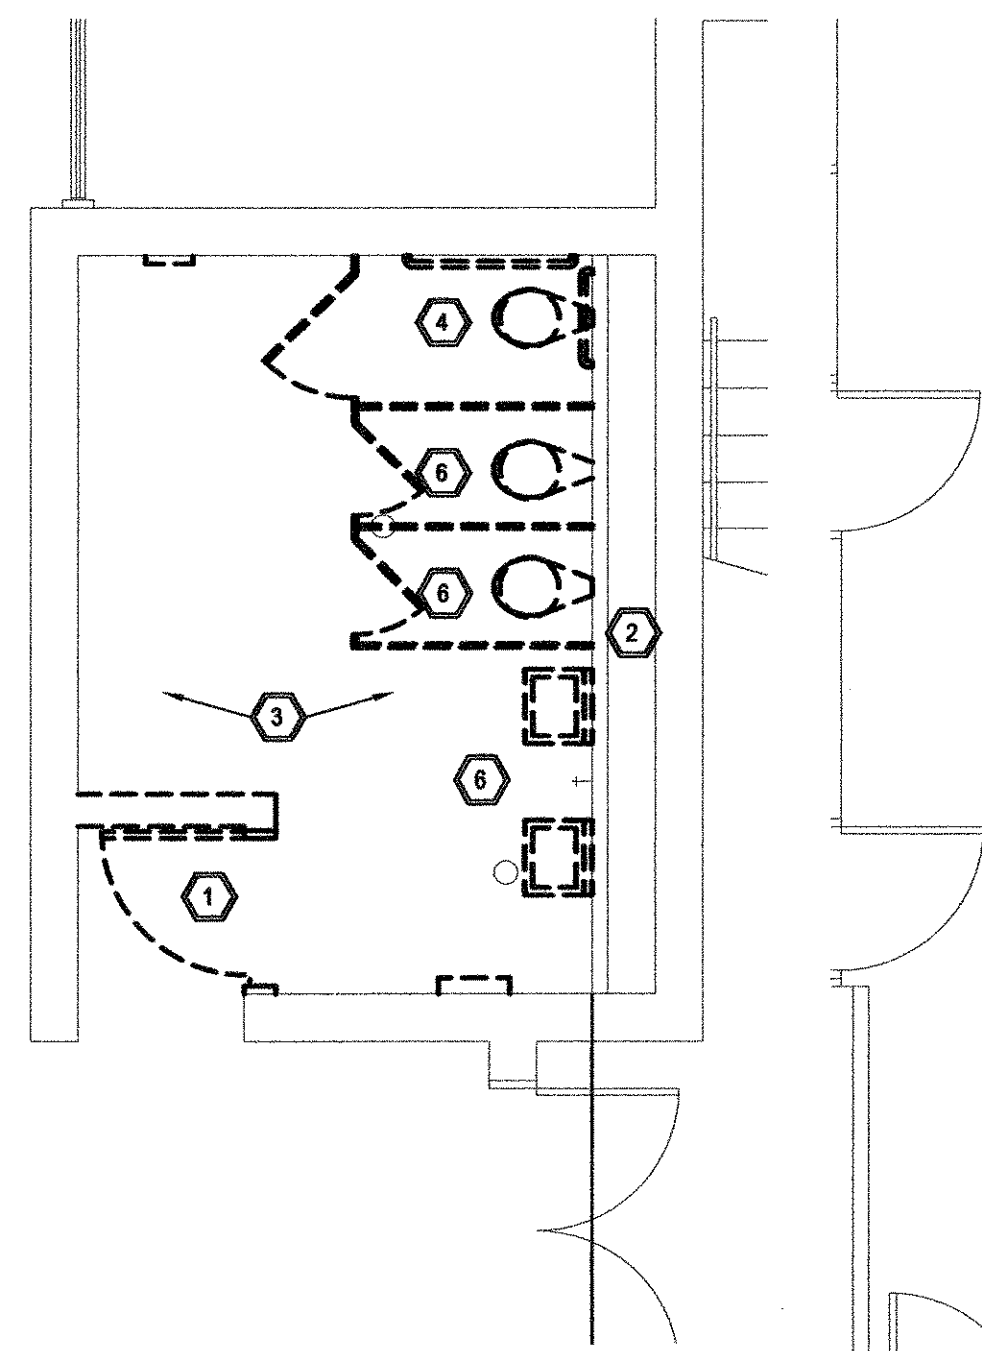


EXISTING / DEMO PLAN

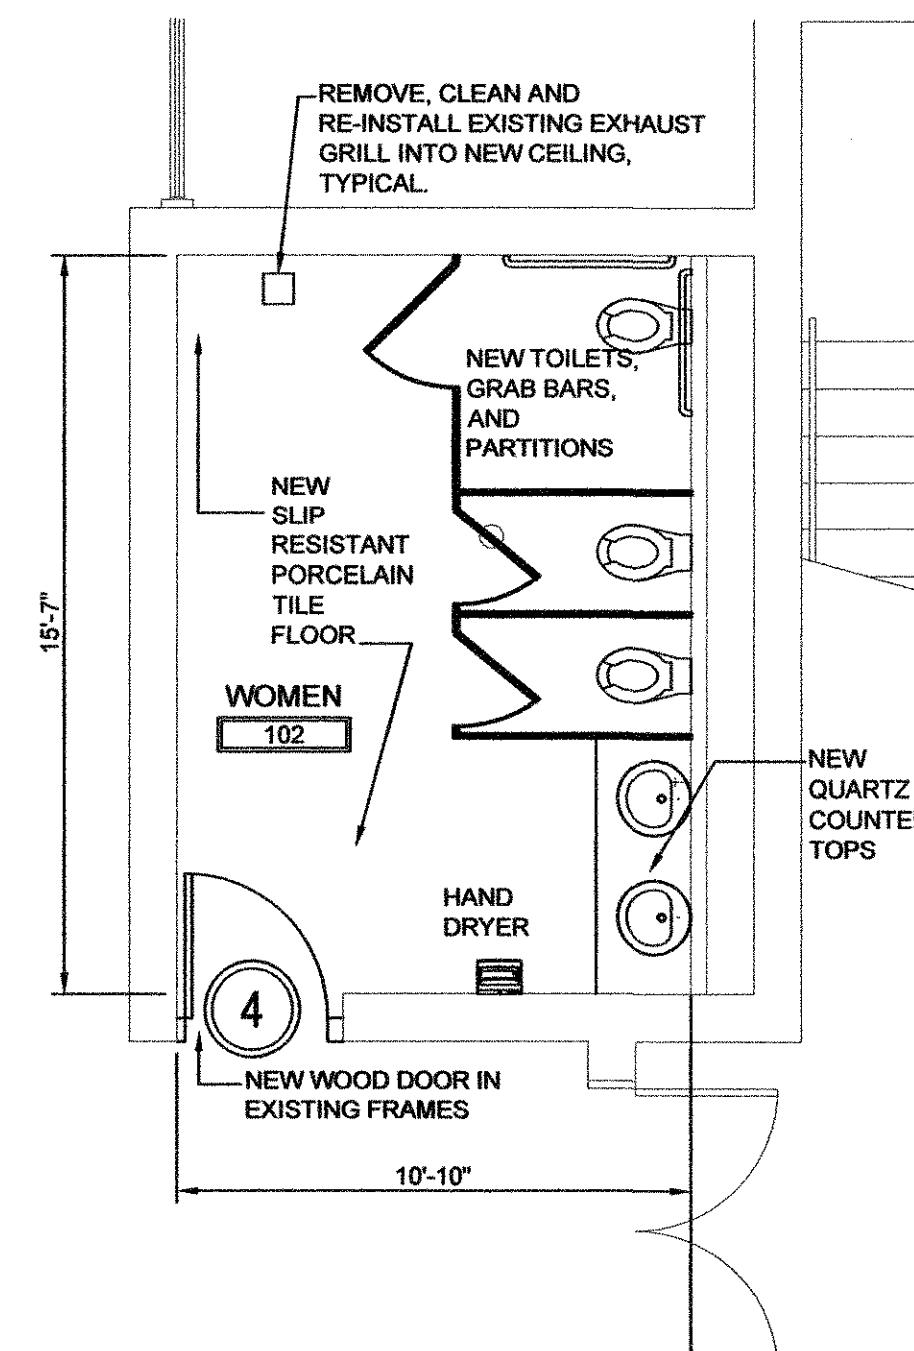

PROPOSED PLAN

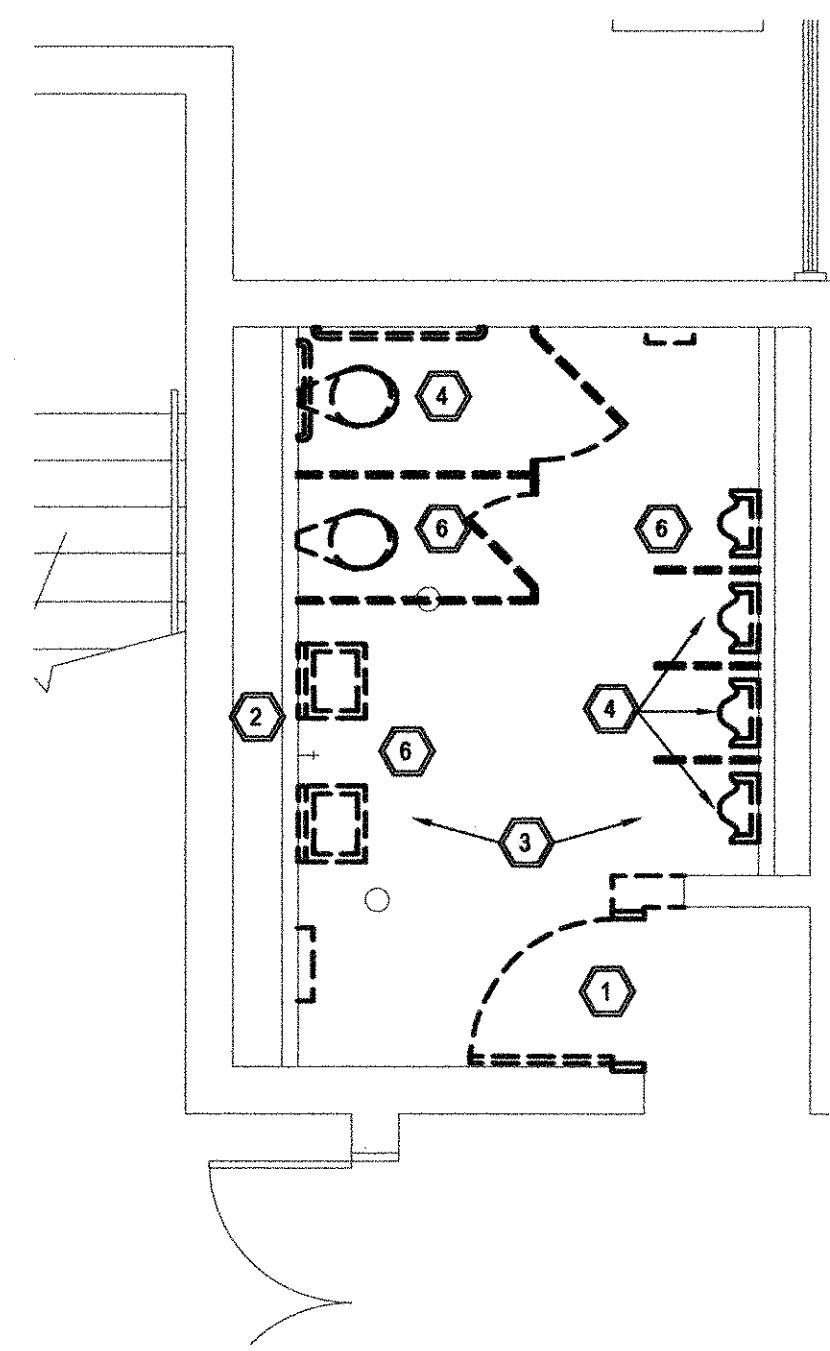

EXISTING / DEMO PLAN

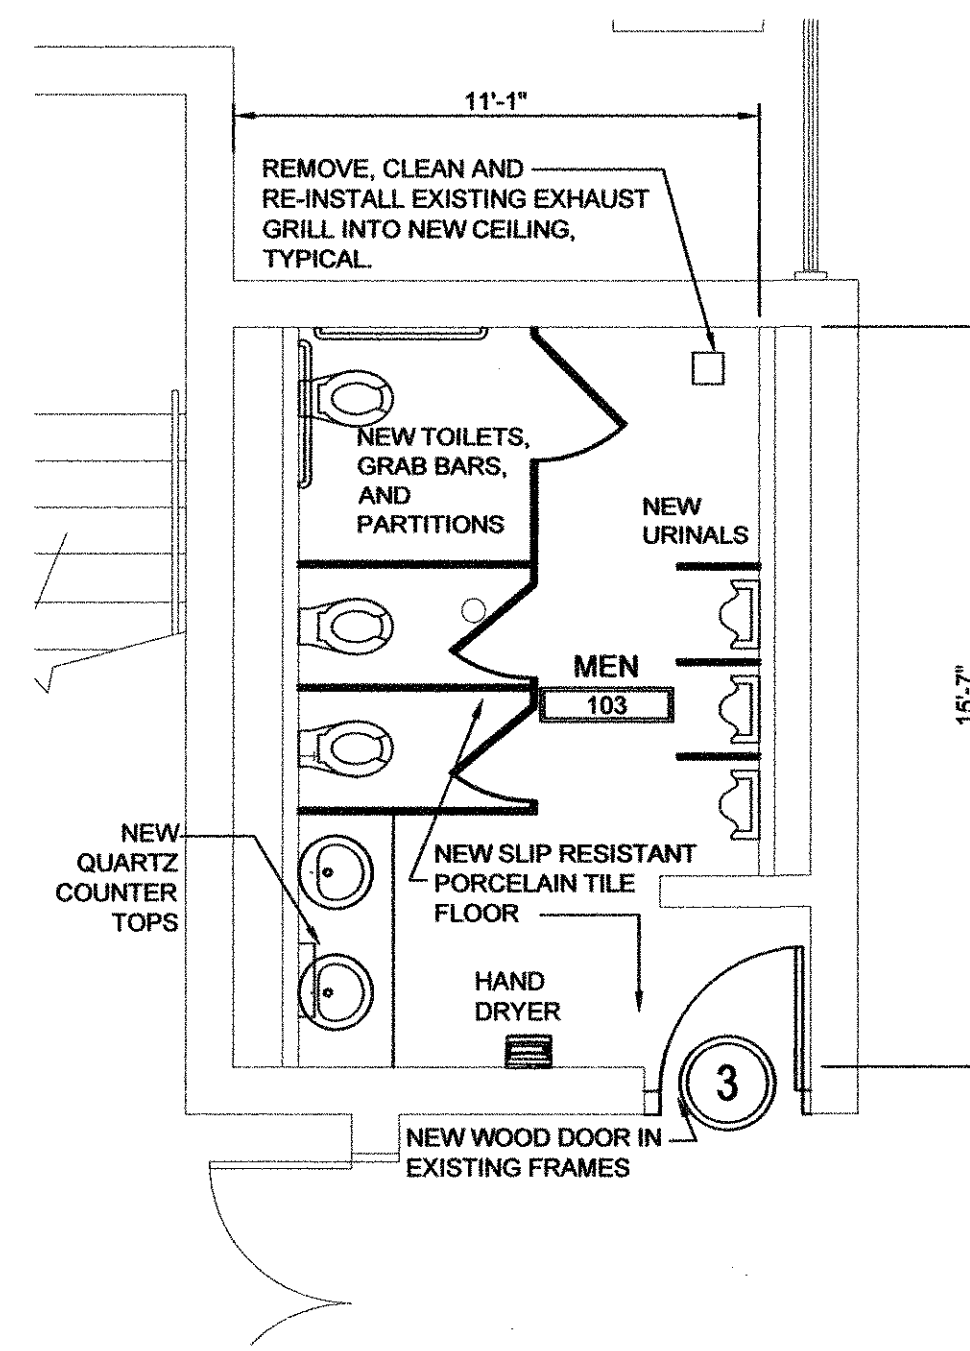

PROPOSED PLAN

DEMOLITION NOTES:

- 1 REMOVE EXISTING DOORS, PLUMBING FIXTURES, LIGHTS, CEILING GRID AND TILE AND STOCKPILE EXISTING MATERIALS TO BE REMOVED. COORDINATE SALVAGING, RECYCLING AND RE-USE W/ OWNER TYP.
- 2 REMOVE PORTION OF EXISTING FLOOR SLAB TO ALLOW FOR NEW INSTALLATION OF SAN SEWER LINE (IN CHASE) PROVIDE TERMITE TREATMENT & INSTALL NEW 15 MIL VAPOR BARRIER & NEW 3000 PSI, 4" THICK, CONCRETE SLAB DOWEL INTO EXISTING SLAB @ 12" O.C.
- 3 REMOVE ALL EXISTING FLOOR EPOXY FLOORING. GRIND DOWN EXISTING CONCRETE FLOOR SURFACE AS REQUIRED TO PREP FLOORS FOR INSTALLATION OF TILE AND BASE.

PLUMBING DEMOLITION NOTES:

- 4 REMOVE EXISTING PLUMBING FIXTURE. PREP AND REUSE EXISTING WASTE AND POTABLE WATER PIPING FOR NEW.
- 5 NOT USED.
- 6 REMOVE EXISTING PLUMBING FIXTURE AND ASSOCIATED PIPING. CAP EXISTING PIPING BELOW FLOOR AND/OR IN PLUMBING CHASE. PATCH EXISTING FLOOR AND WALL PENETRATIONS. MATCH NEW FINISHES.

ELECTRICAL DEMOLITION NOTES:


- 7 PRIOR TO DEMOLITION, VERIFY PROPER OPERATION OF ALL ELECTRICAL WIRING DEVICES AND LIGHTING. VERIFY PROPER OPERATION OF FIRE ALARM DEVICES. NOTE ANY DEFICIENCIES. IT IS OUR BELIEF THAT THERE ARE NO DEFICIENCIES.
- 8 REMOVE AND DISCARD ALL LUMINAIRES AND ASSOCIATED WIRING BACK TO NEAREST JUNCTION BOX.
- 9 REMOVE AND DISCARD ALL SWITCHES AND RECEPTACLES AND ASSOCIATED FACEPLATES. WIRING TO BE REUSED.
- 10 REMOVE ALL FIRE ALARM DEVICES AND STORE IN PROTECTED AREA FOR REINSTALLATION IN SAME LOCATION.

4 WOMEN'S TOILET - SOUTH
SCALE: 1/4" = 1'-0"



5 MEN'S TOILET - SOUTH
SCALE: 1/4" = 1'-0"


SCOPE OF WORK IN THIS CONTRACT SHALL INCLUDE FIRST FLOOR RESTROOM RENOVATIONS IN BASE BID. PROVIDE ADD ALTERNATE #1 FOR SECOND FLOOR RESTROOM RENOVATIONS

NOTE: CONTRACTOR TO FIELD VERIFY ALL DIMENSIONS

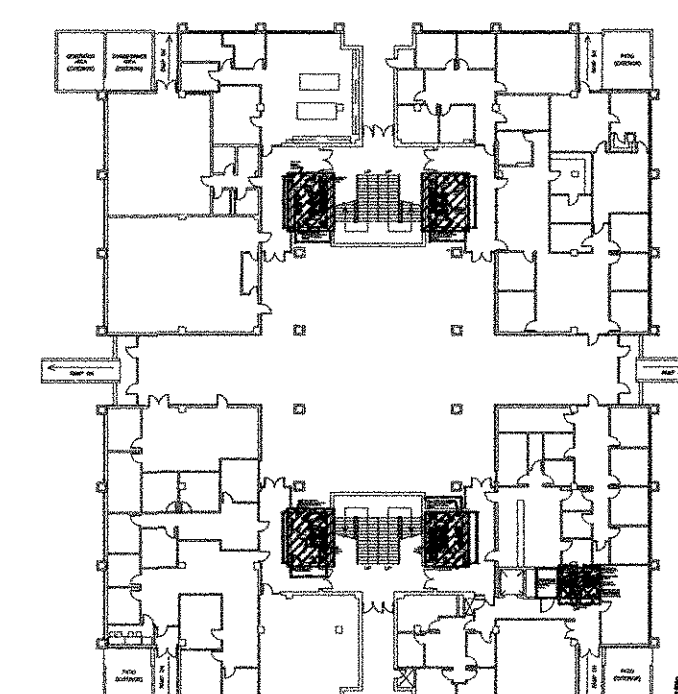


KEY PLAN

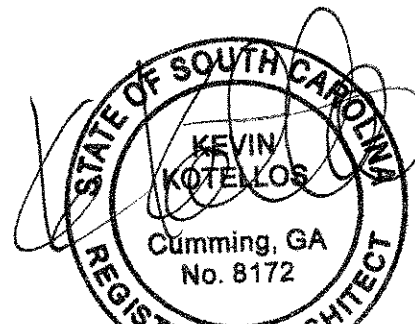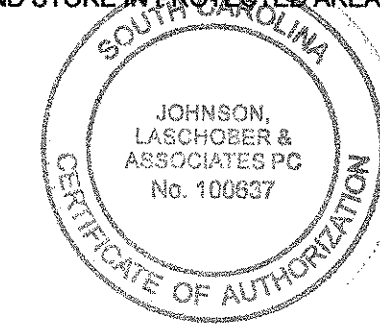


 <p>Since 1980</p> <p>Architects • Engineers • Landscape Architects •</p> <p>www.theJLAgroup.com</p>	<p>USC AIKEN AIKEN, SOUTH CAROLINA</p> <p>PENLAND BUILDING RESTROOM RENOVATIONS</p> <p>FIRST FLOOR RESTROOM PLANS</p>				
	<p>JOHNSON, LASCHOB & ASSOCIATES, P.C.</p> <p>1296 BROAD STREET AUGUSTA, GEORGIA 30901 TEL (706) 724-5736 FAX (706) 724-3955</p>				
	SCALE	DATE	PROJECT NO.	DRAWING NO.	REV.
	1/4"=1'-0"	8/8/2012	6930.1202	A100	0

C:\P\12\1202\Arch\A100 FIRST FLOOR RESTROOM PLANS.dwg REV: 10/27/07 DRE


REV	DATE	BY	DESCRIPTION
0	04/22/2013	KK	ISSUED FOR BID
REVISIONS			
DRAWN BY:	NKM	DATE:	8/8/2012
CHECKED BY:	KK	DATE:	8/8/2012

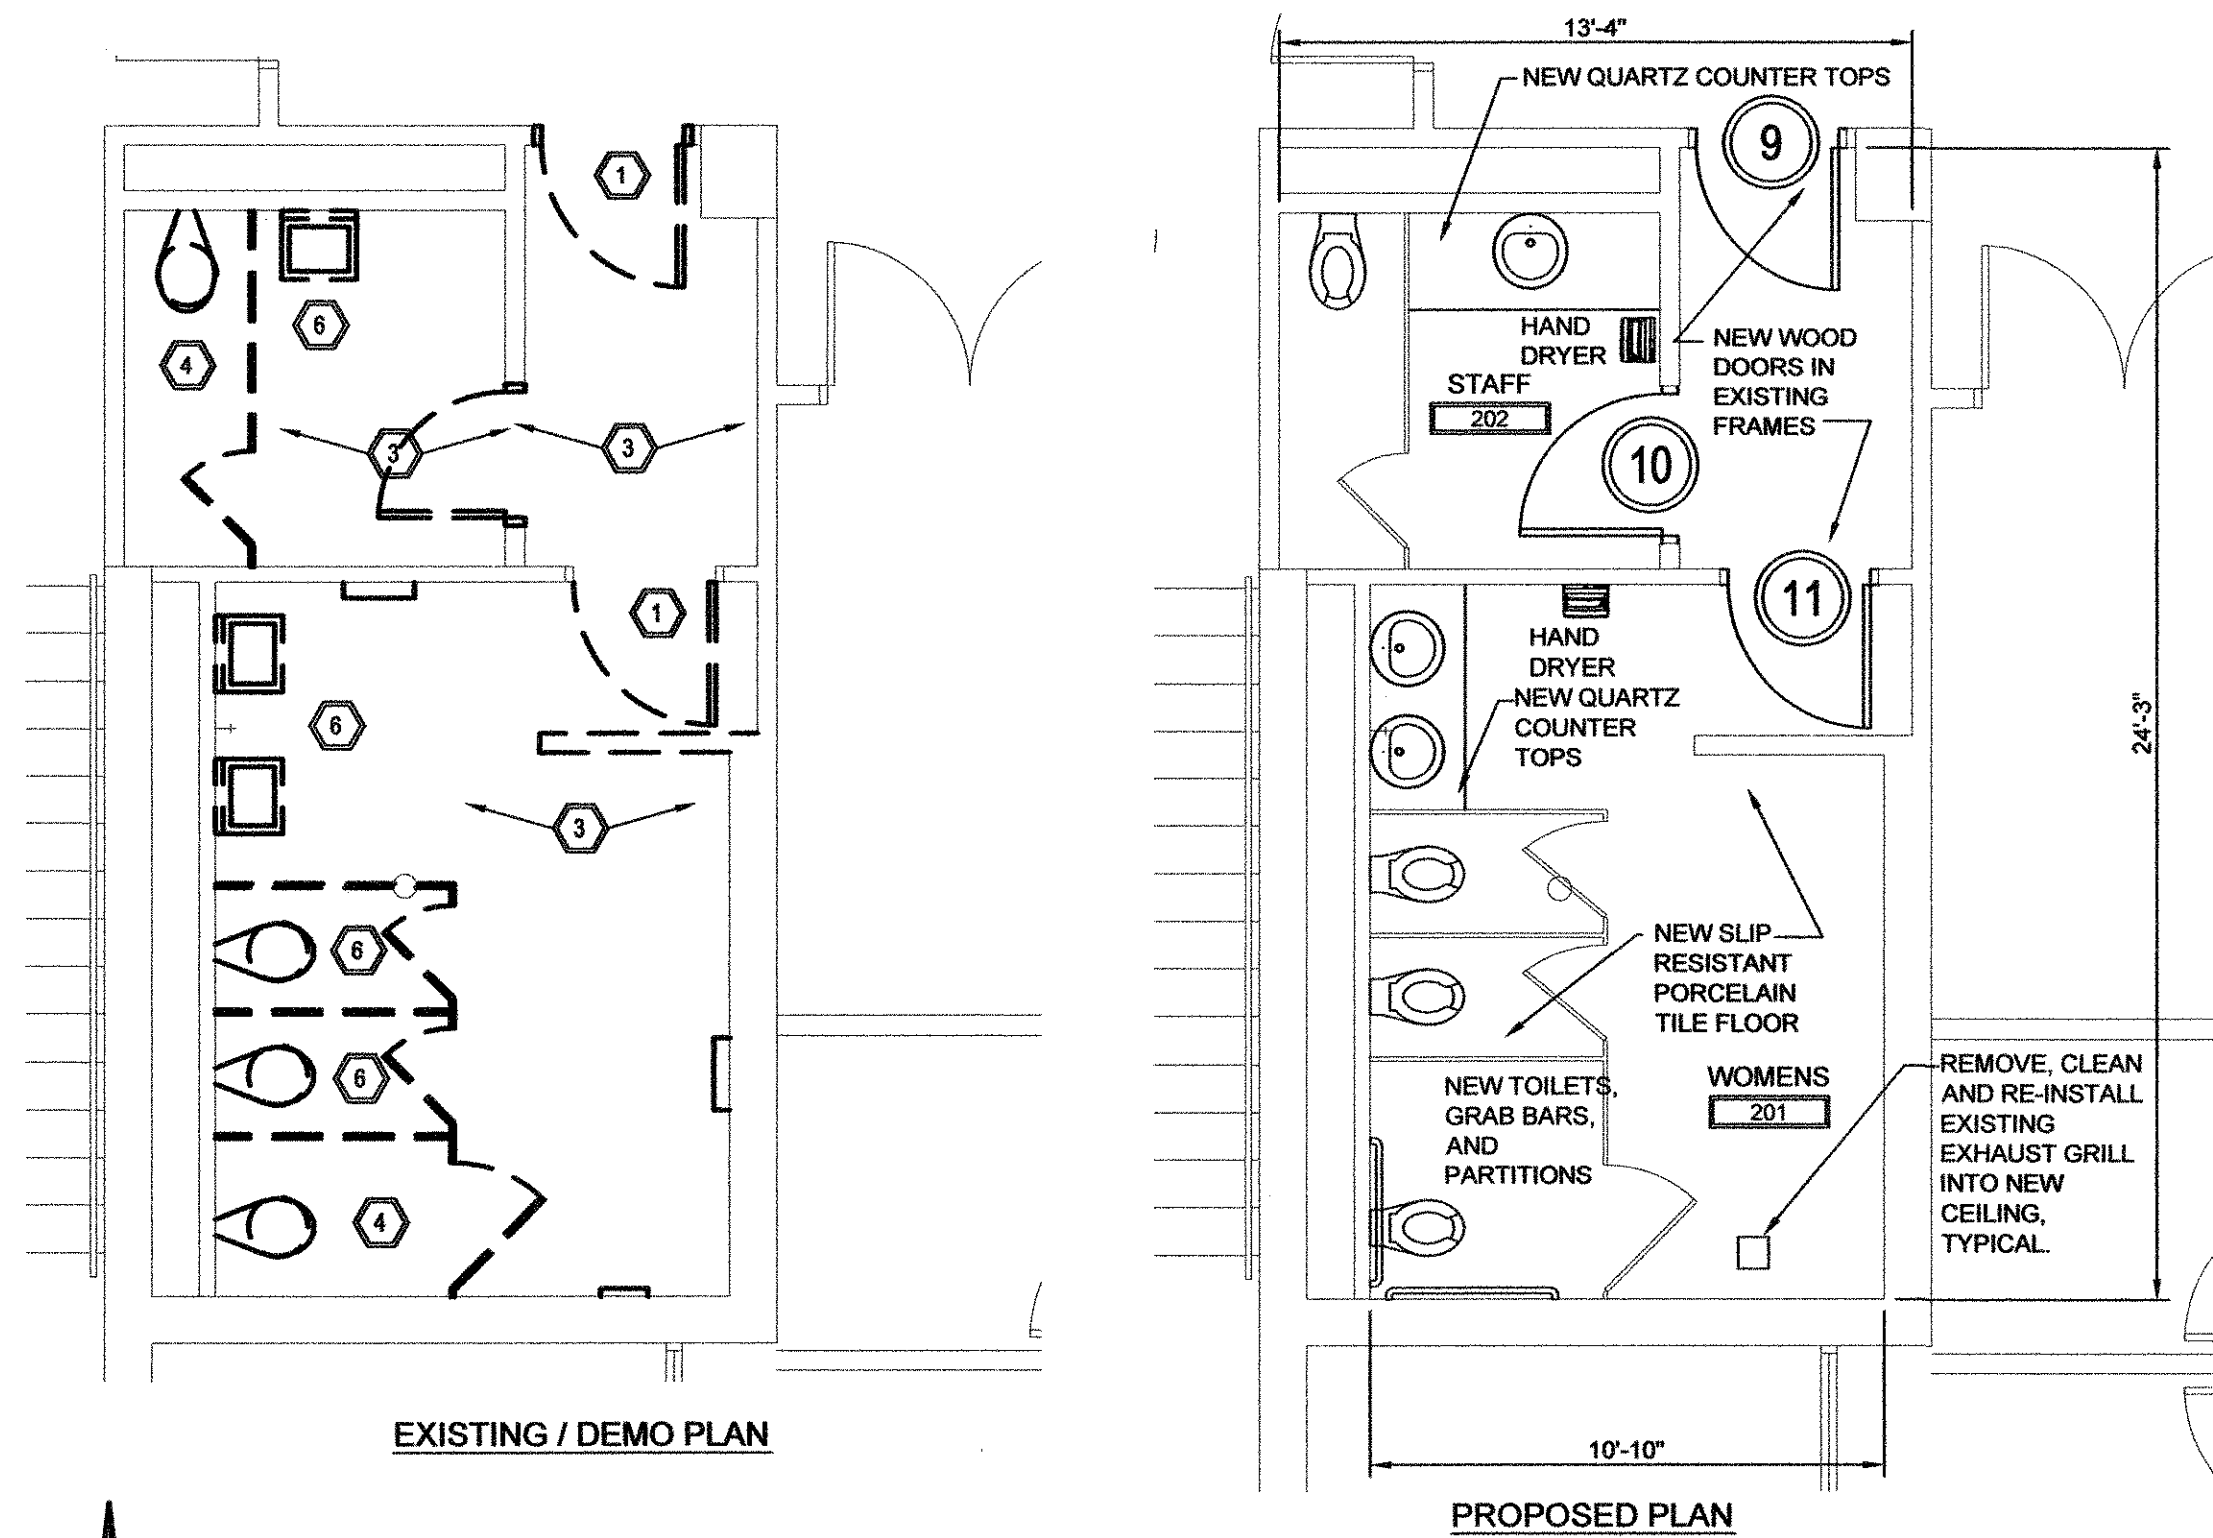


1 WOMEN'S TOILET - NORTH
SCALE: 1/4" = 1'-0"

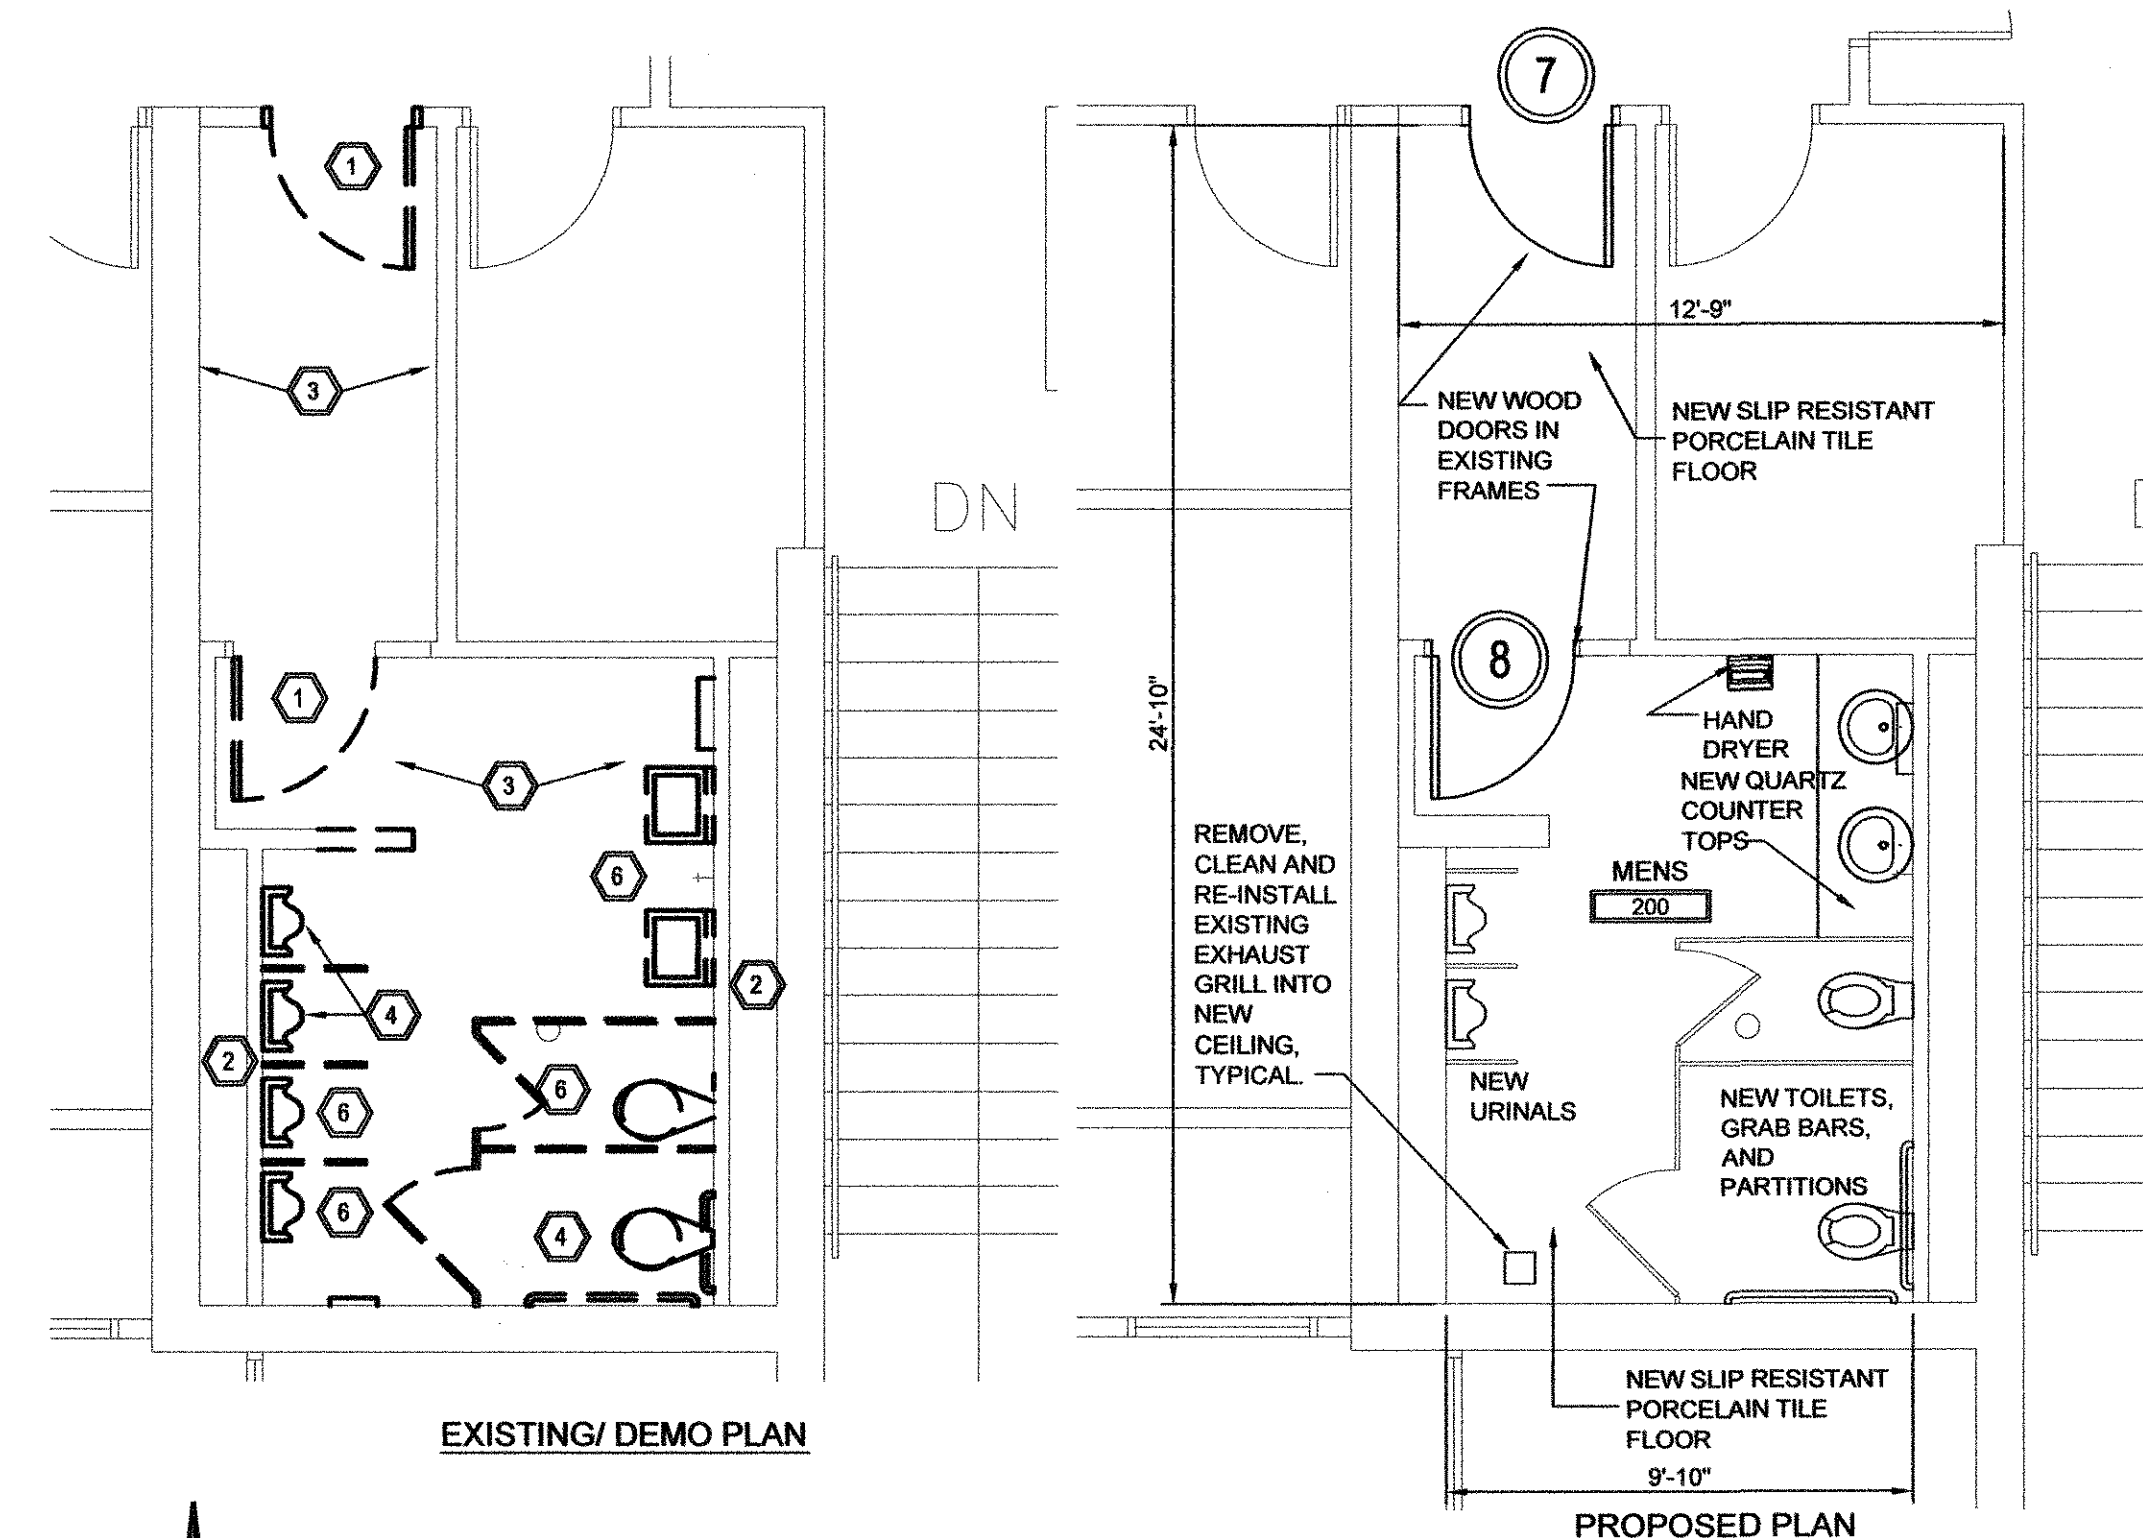

2 MEN'S TOILET - NORTH
SCALE: 1/4" = 1'-0"

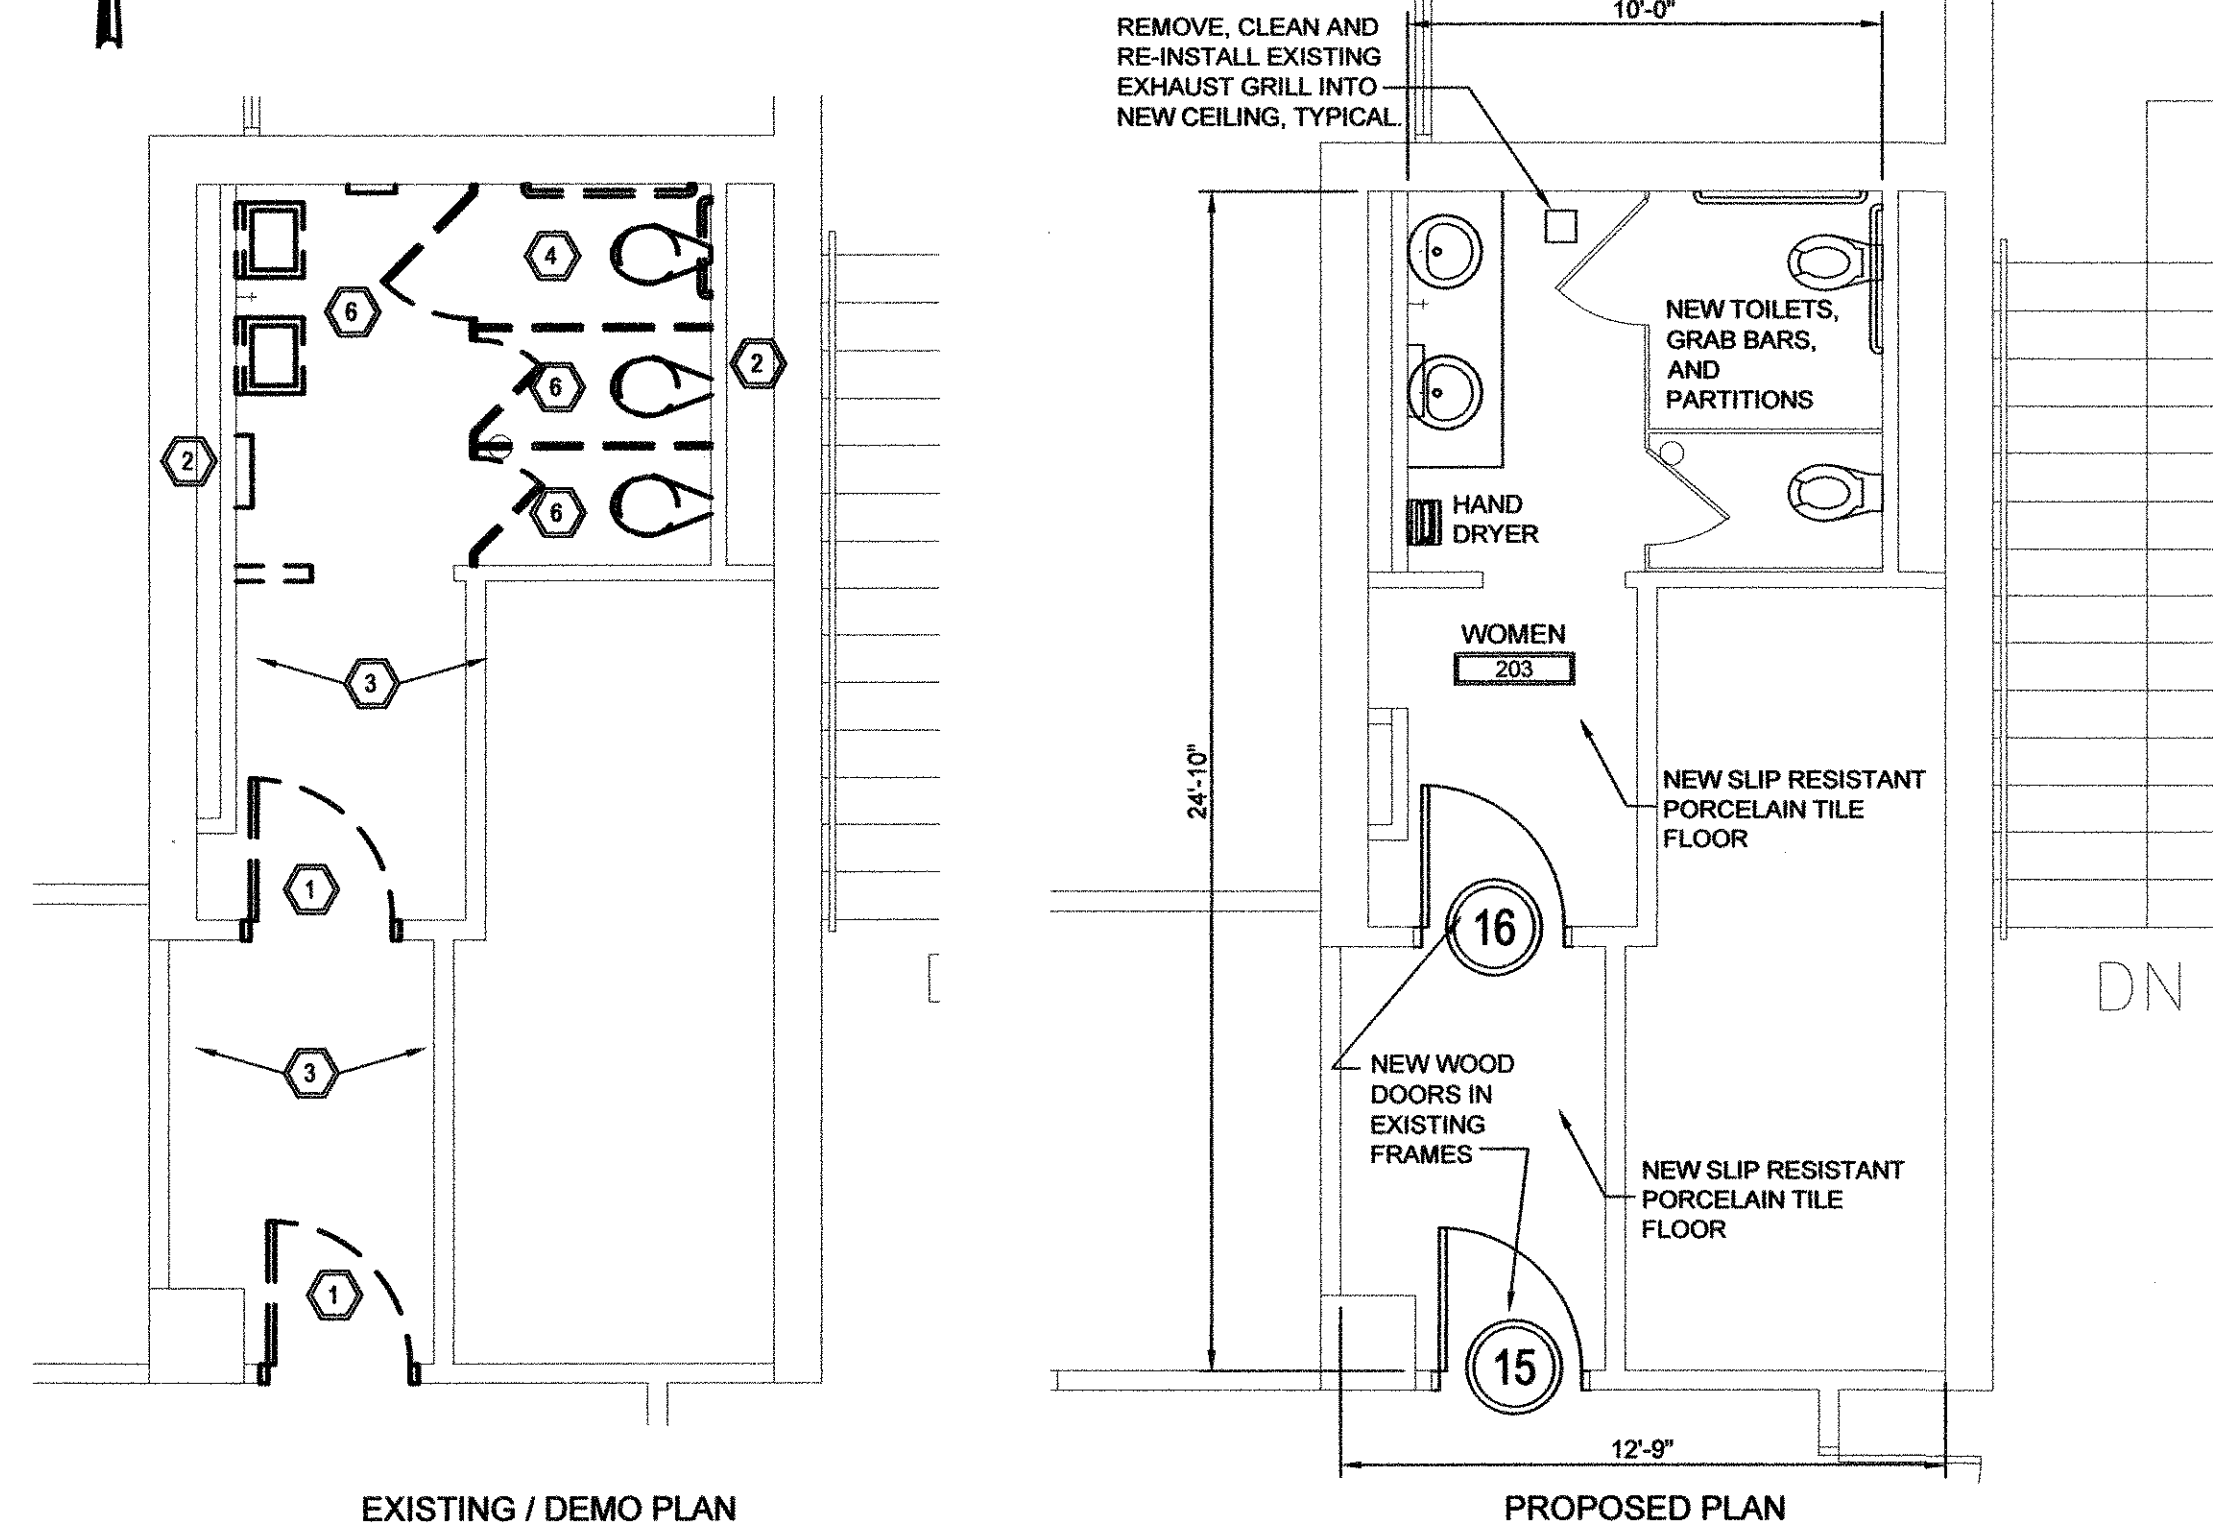


3 WOMEN'S TOILET - SOUTH
SCALE: 1/4" = 1'-0"

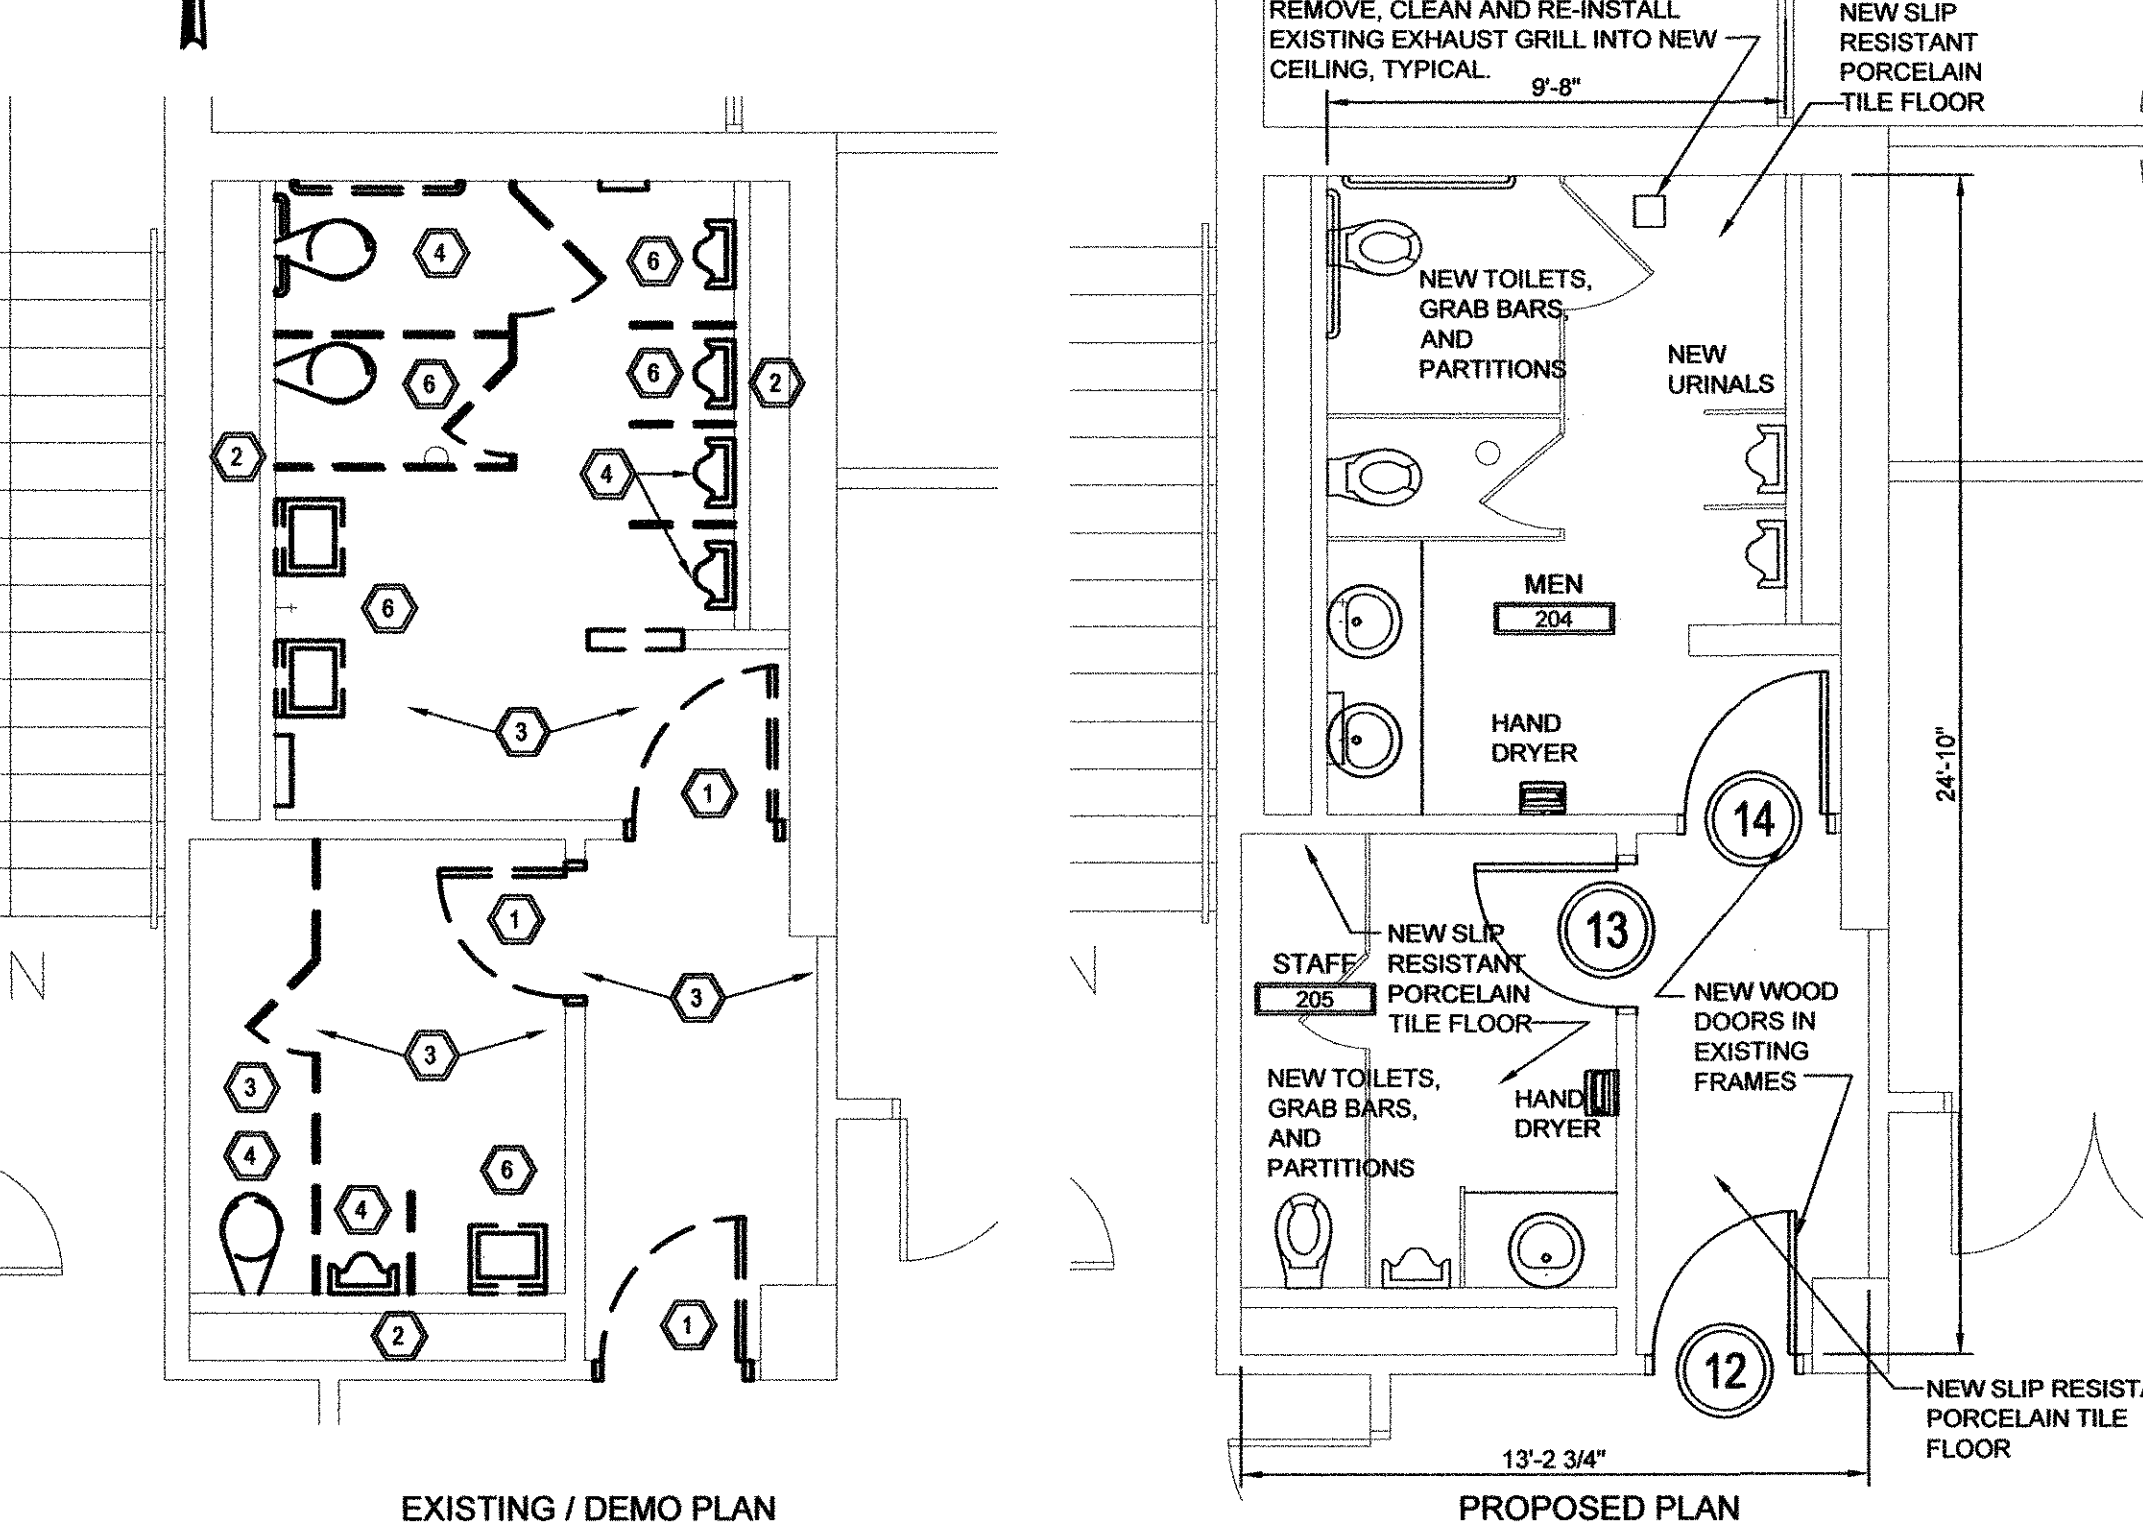

4 MEN'S TOILET - SOUTH
SCALE: 1/4" = 1'-0"

- DEMOLITION NOTES:**
- REMOVE EXISTING DOORS, PLUMBING FIXTURES, LIGHTS, CEILING GRID AND TILE AND STOCKPILE EXISTING MATERIALS TO BE REMOVED. COORDINATE SALVAGING, RECYCLING AND RE-USE W/ OWNER TYP.
 - REMOVE PORTION OF EXISTING FLOOR SLAB TO ALLOW FOR NEW INSTALLATION OF SAN SEWER LINE PROVIDE TERMITE TREATMENT & INSTALL NEW 15 MIL VAPOR BARRIER & NEW 3000 PSI, 4" THICK, CONCRETE SLAB DOWEL INTO EXISTING SLAB @ 12" O.C.
 - REMOVE ALL EXISTING FLOOR EPOXY FLOORING. GRIND DOWN EXISTING CONCRETE FLOOR SURFACE AS REQUIRED TO PREP FLOORS FOR INSTALLATION OF TILE AND BASE. ADJUST EXISTING FLOOR DRAIN TO ACCOMMODATE NEW FLOOR TILE.
- PLUMBING DEMOLITION NOTES:**
- REMOVE EXISTING PLUMBING FIXTURE. PREP AND REUSE EXISTING WASTE AND POTABLE WATER PIPING FOR NEW.
 - NOT USED.
 - REMOVE EXISTING PLUMBING FIXTURE AND ASSOCIATED PIPING. CAP EXISTING PIPING BELOW FLOOR AND/OR IN PLUMBING CHASE. PATCH EXISTING FLOOR AND WALL PENETRATIONS. MATCH NEW FINISHES.
- ELECTRICAL DEMOLITION NOTES:**
- PRIOR TO DEMOLITION, VERIFY PROPER OPERATION OF ALL ELECTRICAL WIRING DEVICES AND LIGHTING. VERIFY PROPER OPERATION OF FIRE ALARM DEVICES. NOTE ANY DEFICIENCIES. IT IS OUR BELIEF THAT THERE ARE NO DEFICIENCIES.
 - REMOVE AND DISCARD ALL LUMINAIRES AND ASSOCIATED WIRING BACK TO NEAREST JUNCTION BOX.
 - REMOVE AND DISCARD ALL SWITCHES AND RECEPTACLES AND ASSOCIATED FACEPLATES. WIRING TO BE REUSED.
 - REMOVE ALL FIRE ALARM DEVICES AND STORE IN PROTECTED AREA FOR REINSTALLATION IN SAME LOCATION.

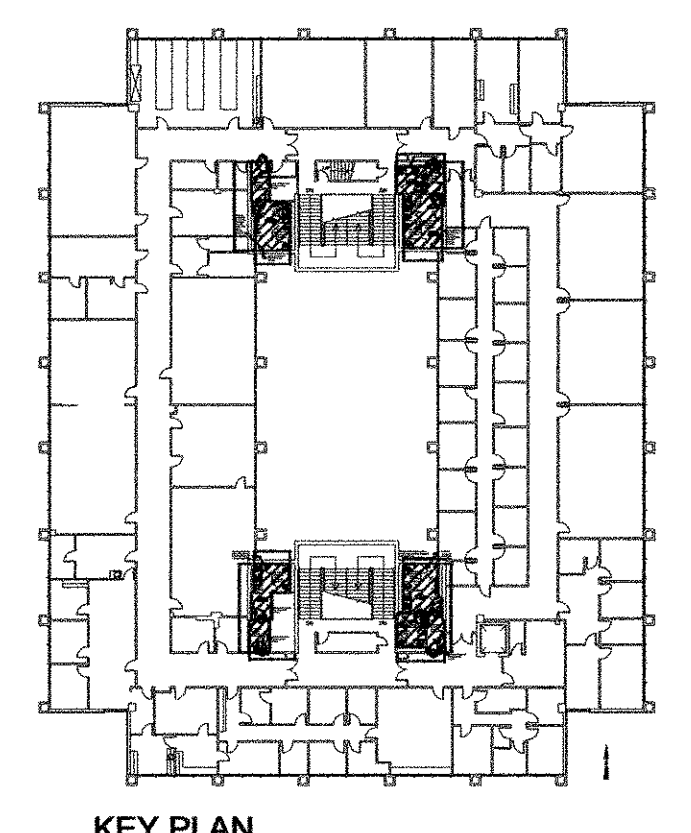

SCOPE OF WORK IN THIS CONTRACT SHALL INCLUDE FIRST FLOOR RESTROOM RENOVATIONS IN BASE BID.
PROVIDE ADD ALTERNATE #1 FOR SECOND FLOOR RESTROOM RENOVATIONS

NOTE: CONTRACTOR TO FIELD VERIFY ALL DIMENSIONS

REV	DATE	BY	DESCRIPTION
0	04/22/2013	KK	ISSUED FOR BID
REVISIONS			
DRAWN BY:	NKM	DATE:	8/8/2012
CHECKED BY:	KK	DATE:	8/8/2012

Since 1980

Architects
Engineers
Landscape Architects

www.theJLAgroup.com

USC AIKEN
AIKEN, SOUTH CAROLINA

PENLAND BUILDING RESTROOM RENOVATIONS
SECOND FLOOR RESTROOM PLANS

JOHNSON, LASCHOBER & ASSOCIATES, P.C.
1296 BROAD STREET
TEL (706) 724-5756

AUGUSTA, GEORGIA 30901
FAX (706) 724-3955

SCALE	DATE	PROJECT NO.	DRAWING NO.	REV.
1/4"=1'-0"	8/8/2012	6930.1202	A101	0



REMOVE VCT AND EPOXY FLOORING AND REPLACE WITH SLIP RESISTANT HARD TILE




REMOVE EXISTING PAPER TOWEL DISPENSER, LAVATORIES, MIRRORS, ETC. TO ALLOW FOR INSTALLATION OF NEW FIXTURES. PATCH WALLS AND PREP TO RECEIVE NEW WALL SURFACES



EXISTING URINALS TO BE REMOVED. CAP EXISTING WATER LINE, CONNECT EXISTING WASTE LINE TO NEW WATERLESS URINALS, TYP.




REMOVE EXISTING WALL HEATER, ABANDON EXISTING ELECTRICAL SERVICE. PATCH AND REPAIR WALL. WALL TO RECEIVE NEW WALL TREATMENT OF TILE.

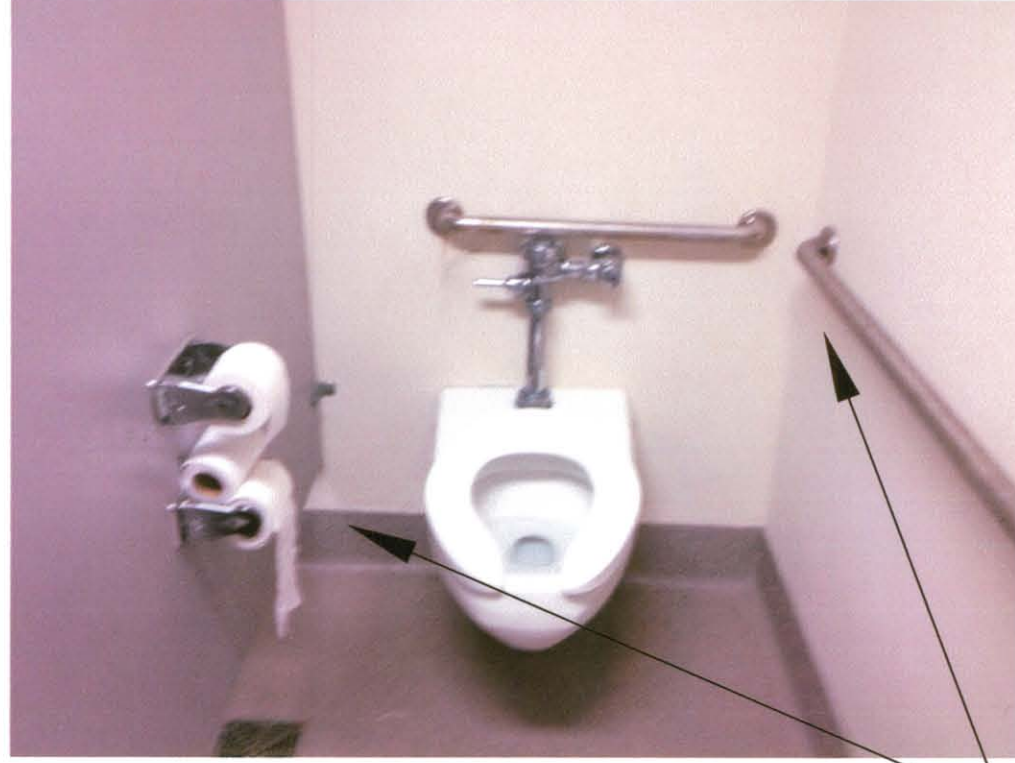

REMOVE EXISTING TOILET, GRAB BARS, TOILET PARTITIONS. PREP WALLS AND FLOOR FOR INSTALLATION OF NEW WALL AND FLOOR SURFACES.



REMOVE EXISTING PAPER TOWEL DISPENSER, LAVATORIES, MIRRORS, ETC. TO ALLOW FOR INSTALLATION OF NEW FIXTURES. PATCH WALLS AND PREP TO RECEIVE NEW WALL SURFACES

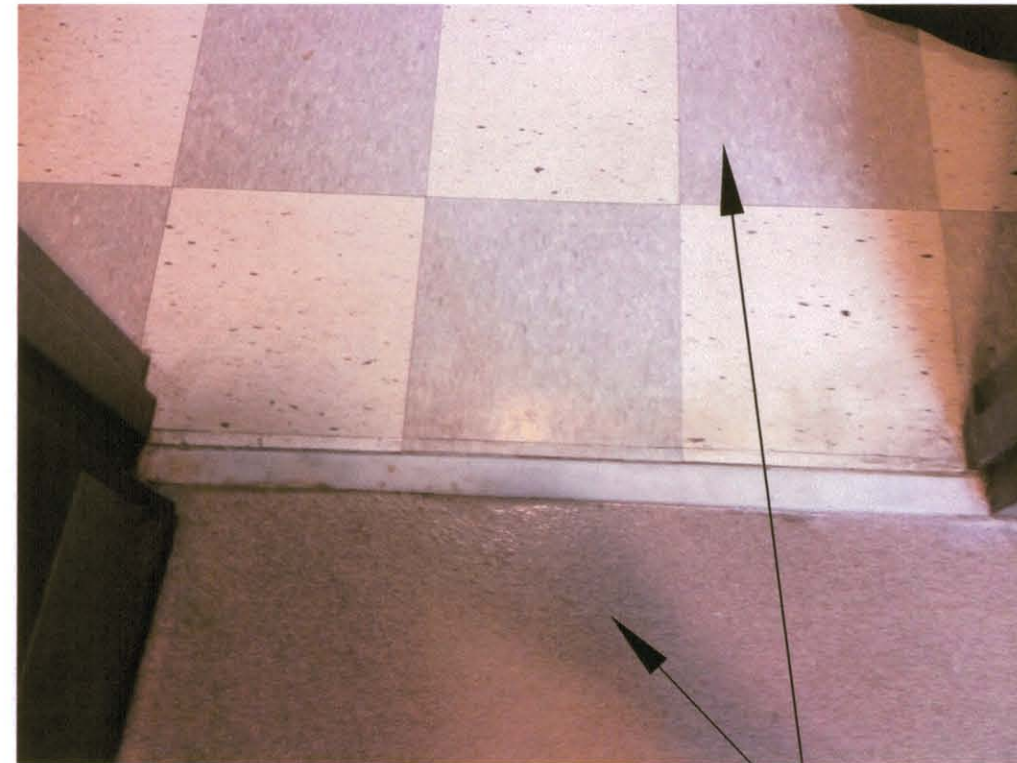

REMOVE VCT AND EPOXY FLOORING AND REPLACE WITH SLIP RESISTANT HARD TILE



EXISTING HOSE BIBB TO BE ABANDONED. PROVIDE NEW HOSE BIBB SEE PLUMBING PLANS.



REMOVE VCT AND EPOXY FLOORING AND REPLACE WITH SLIP RESISTANT HARD TILE



REMOVE EXISTING LIGHTING OVER LAVATORIES. PREP WALL TO RECEIVE NEW LIGHT FIXTURE AND PATCH AND REPAIR WALL TO RECEIVE NEW TILE AND WALL COVERING



REMOVE AND STOCKPILE EXISTING DOORS, AND REPLACE WITH NEW SOLID CORE WOOD DOORS



REMOVE EXISTING PAPER TOWEL DISPENSER, LAVATORIES, MIRRORS, ETC. TO ALLOW FOR INSTALLATION OF NEW FIXTURES. PATCH WALLS AND PREP TO RECEIVE NEW WALL SURFACES



REMOVE EXISTING CEILING, LIGHTING AND FIRE ALARM DEVICES, AND RE INSTALL FIRE ALARM DEVICES INTO NEW CEILING, VERIFY PROPER WORKING CONDITION PRIOR TO REINSTALLATION



REMOVE AND STOCKPILE EXISTING DOORS, AND REPLACE WITH NEW SOLID CORE WOOD DOORS. PREP EXISTING DOOR FRAMES AND SOLID TRANSOMS TO REMAIN TO ALLOW FOR SMOOTH APPLICATION OF NEW PAINT



EXISTING URINALS TO BE REMOVED. CAP EXISTING WATER LINE, CONNECT EXISTING WASTE LINE TO NEW WATERLESS URINALS, TYP.



REMOVE VCT AND EPOXY FLOORING AND REPLACE WITH SLIP RESISTANT HARD TILE




REMOVE EXISTING TOILET PARTITIONS, RESTROOM SIGNAGE AND FIXTURES TO ALLOW FOR INSTALLATION OF NEW ITEMS, TYPICAL.

SCOPE OF WORK IN THIS CONTRACT SHALL INCLUDE FIRST FLOOR RESTROOM RENOVATIONS IN BASE BID. PROVIDE ADD ALTERNATE #1 FOR SECOND FLOOR RESTROOM RENOVATIONS

1
A102
SCALE: NTS
EXISTING RESTROOMS

REV	DATE	BY	DESCRIPTION
0	1/16/2013	KK	ISSUED FOR BID
REVISIONS			
DRAWN BY: NKM DATE: 8/8/2012 CHECKED BY: KK DATE: 8/8/2012			

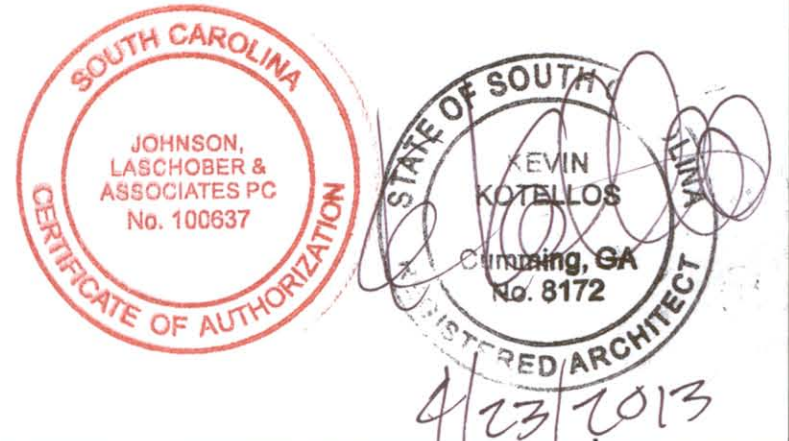



Since 1980

Architects
Engineers
Landscape Architects

www.theJLAgroup.com

USC AIKEN
AIKEN, SOUTH CAROLINA

PENLAND BUILDING RESTROOM RENOVATIONS

PHOTOGRAPHS OF EXISTING RESTROOMS

JOHNSON, LASCHOB & ASSOCIATES, P.C.
1296 BROAD STREET
TEL (706) 724-5756

AUGUSTA, GEORGIA 30901
FAX (706) 724-3955

SCALE	DATE	PROJECT NO.	DRAWING NO.	REV.
1/4"=1'-0"	8/8/2012	6930.1202	A102	0

ROOM FINISH SCHEDULE

NO.	NAME	FLOOR	WALL	BASE	CEILING	COMMENTS
100	MEN	TILE	TILE/WALL COVERING	TILE	9'-0" ACT	
101	WOMEN	TILE	TILE/WALL COVERING	TILE	9'-0" ACT	
102	WOMEN	TILE	TILE/WALL COVERING	TILE	9'-0" ACT	
103	MEN	TILE	TILE/WALL COVERING	TILE	9'-0" ACT	
104	STAFF	TILE	TILE/WALL COVERING	TILE	9'-0" ACT	
105	STAFF	TILE	TILE/WALL COVERING	TILE	9'-0" ACT	
200	MEN	TILE	TILE/WALL COVERING	TILE	8'-0" ACT	
201	WOMEN	TILE	TILE/WALL COVERING	TILE	8'-0" ACT	
202	STAFF	TILE	TILE/WALL COVERING	TILE	8'-0" ACT	
203	WOMEN	TILE	TILE/WALL COVERING	TILE	8'-0" ACT	
204	MEN	TILE	TILE/WALL COVERING	TILE	8'-0" ACT	
205	STAFF	TILE	TILE/WALL COVERING	TILE	8'-0" ACT	

DOOR SCHEDULE


DR. NO.	ELEV.	FRAME	SIZE	MAT'L. TYPE	REMARK
FIRST FLOOR PLAN					
1	D1	EXISTING	3' x 7'	SOLID CORE WOOD	EXISTING FRAME TO BE RELOCATED, REUSED WITH NEW DOOR
2	D1	EXISTING	3' x 7'	SOLID CORE WOOD	EXISTING FRAME TO BE RELOCATED, REUSED WITH NEW DOOR
3	D1	EXISTING	3' x 7'	SOLID CORE WOOD	EXISTING FRAME TO BE RELOCATED, REUSED WITH NEW DOOR
4	D1	EXISTING	3' x 7'	SOLID CORE WOOD	EXISTING FRAME TO BE RELOCATED, REUSED WITH NEW DOOR
5	D2	EXISTING	3' x 7'	SOLID CORE WOOD	EXISTING FRAME REUSED WITH NEW DOOR
6	D2	EXISTING	3' x 7'	SOLID CORE WOOD	EXISTING FRAME REUSED WITH NEW DOOR
7	D1	EXISTING	3' x 7'	SOLID CORE WOOD	
8	D1	EXISTING	3' x 7'	SOLID CORE WOOD	
9	D1	EXISTING	3' x 7'	SOLID CORE WOOD	
10	D1	EXISTING	3' x 7'	SOLID CORE WOOD	
11	D1	EXISTING	3' x 7'	SOLID CORE WOOD	
12	D1	EXISTING	3' x 7'	SOLID CORE WOOD	
13	D1	EXISTING	3' x 7'	SOLID CORE WOOD	
14	D1	EXISTING	3' x 7'	SOLID CORE WOOD	
15	D1	EXISTING	3' x 7'	SOLID CORE WOOD	
16	D1	EXISTING	3' x 7'	SOLID CORE WOOD	

NOTES:


- ALL FRAMES AND TRANSOMS SHALL BE PRIMED AND RECEIVE 2 COATS FIELD PAINT. FINAL COAT HIGH GLOSS ENAMEL.
- SOLID CORE WOOD DOORS SHALL BE WDMA IS-1A PERFORMANCE GRADE: EXTRA HEAVY DUTY, WITH GRADE: PREMIUM GRADE AA FACES, FACTORY PREMIUM GRADE TRANSPARENT FINISH, SPECIES WALNUT, CUT: MATCH BETWEEN VENEER LEAVES. BOOK

EACH DOOR TO RECEIVE:
 STANLEY 3 EA BUTTS
 ROCKWOOD 1 EA KICK PLATE
 ROCKWOOD 1 EA WALL STOP
 ROCKWOOD 3 EA SILENCERS
 ROCKWOOD 1 EA PULL
 ROCKWOOD 2 EA PUSH PLATES
 FALCON 1 EA DOOR CLOSER


FBB179 4.5 X 4.5 X US26D
 409 X 630
 608
 T112, 630
 70RCE, 630
 SC70-3049DS, DEAD STOP HOLD OPEN ARM

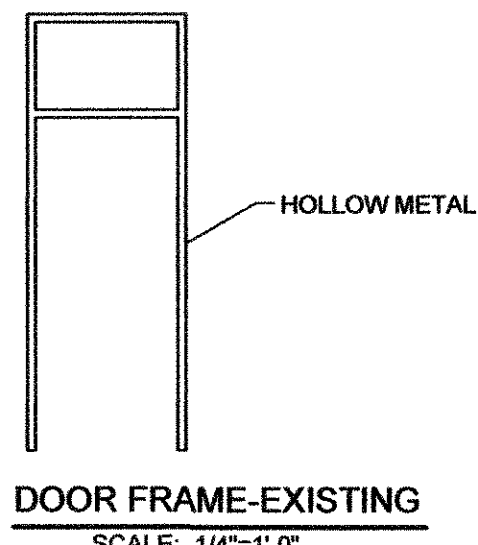


DOOR FRAME-EXISTING
SCALE: 1/4"=1'-0"

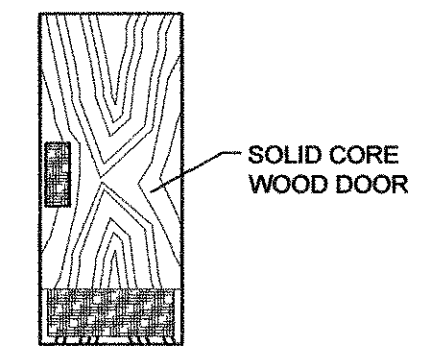


DOOR ELEVATION
SCALE: 1/4"=1'-0"

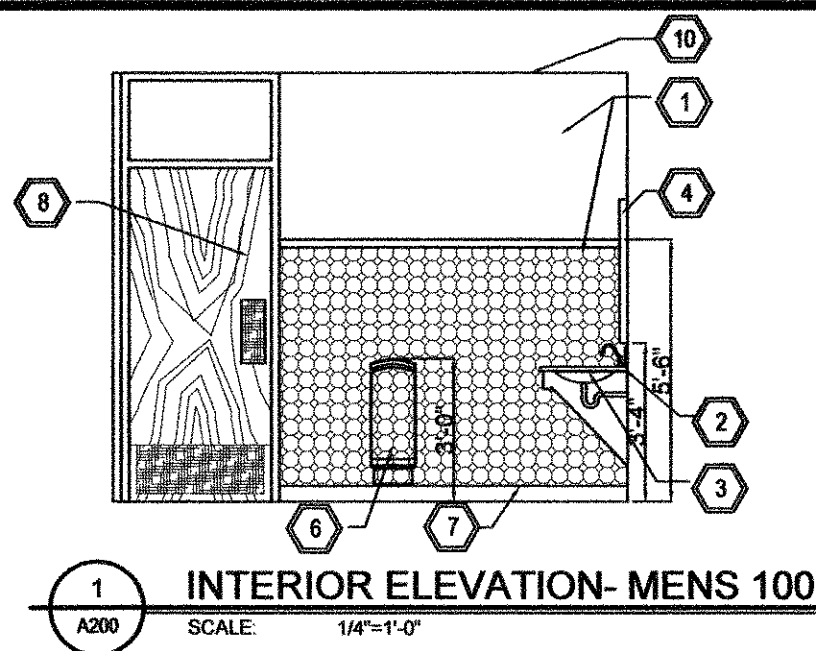


1 INTERIOR ELEVATION- MENS 100
SCALE: 1/4"=1'-0"

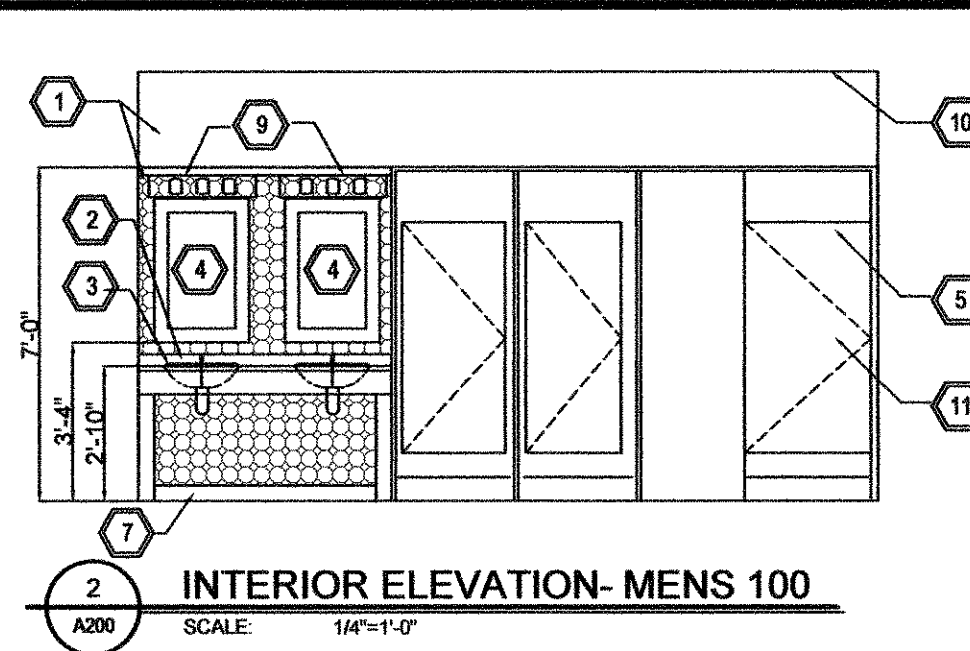


2 INTERIOR ELEVATION- MENS 100
SCALE: 1/4"=1'-0"

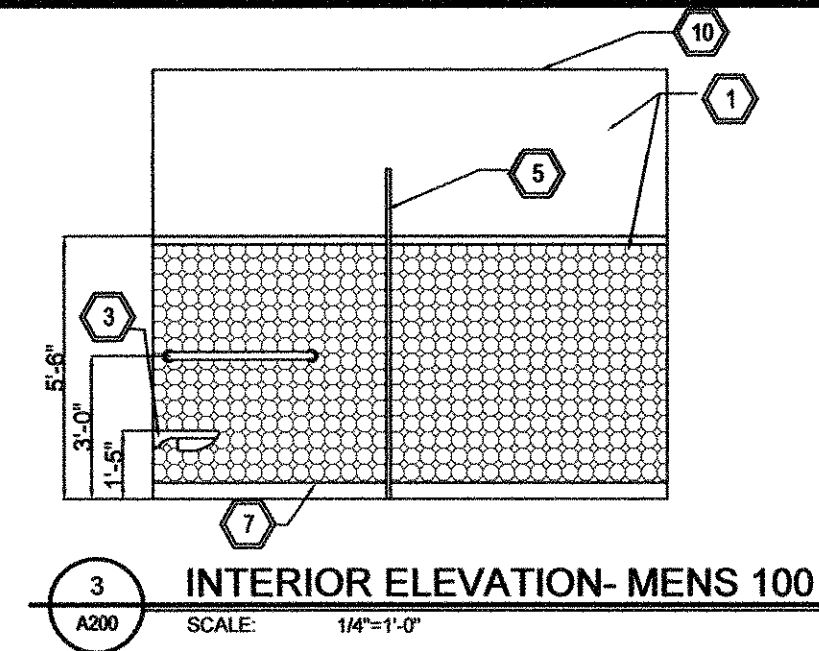


3 INTERIOR ELEVATION- MENS 100
SCALE: 1/4"=1'-0"

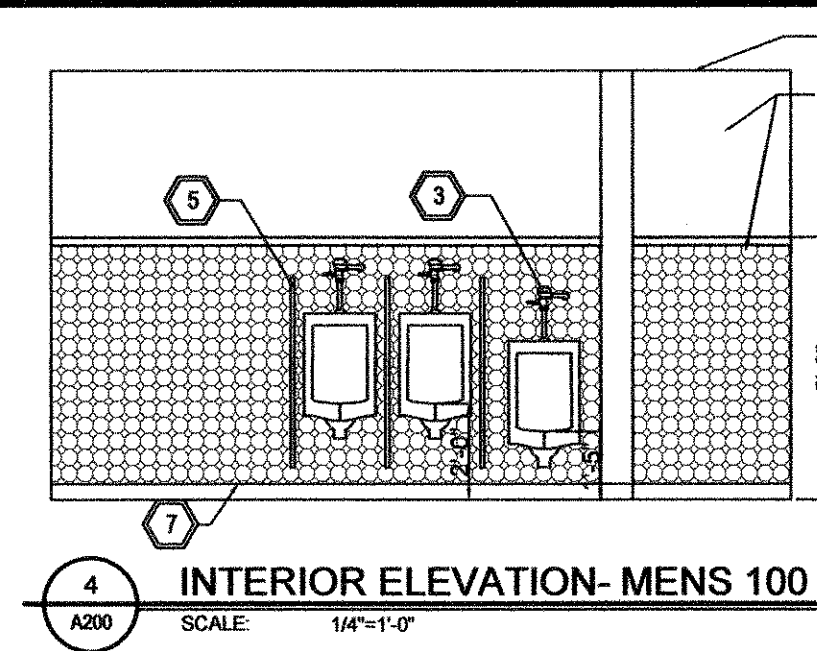


4 INTERIOR ELEVATION- MENS 100
SCALE: 1/4"=1'-0"

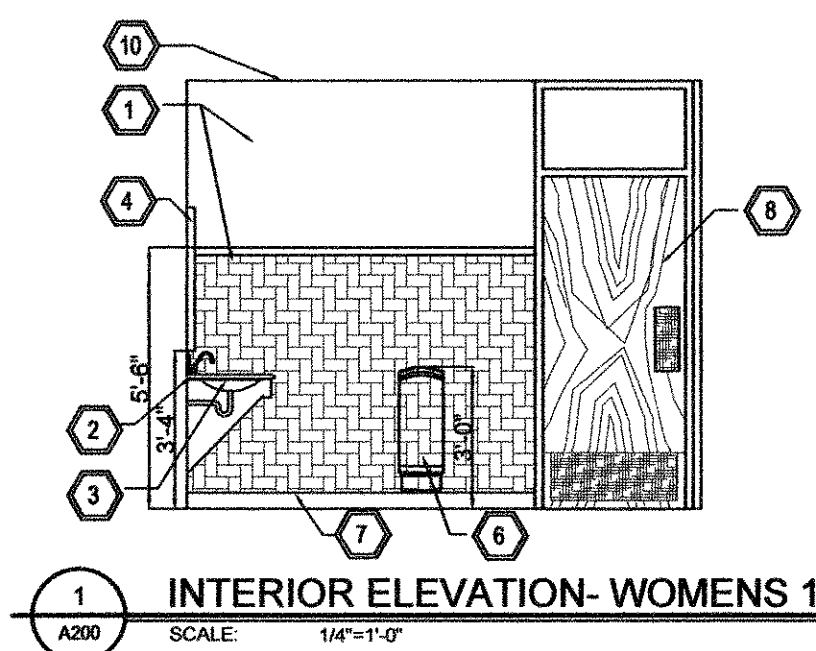


1 INTERIOR ELEVATION- WOMENS 101
SCALE: 1/4"=1'-0"

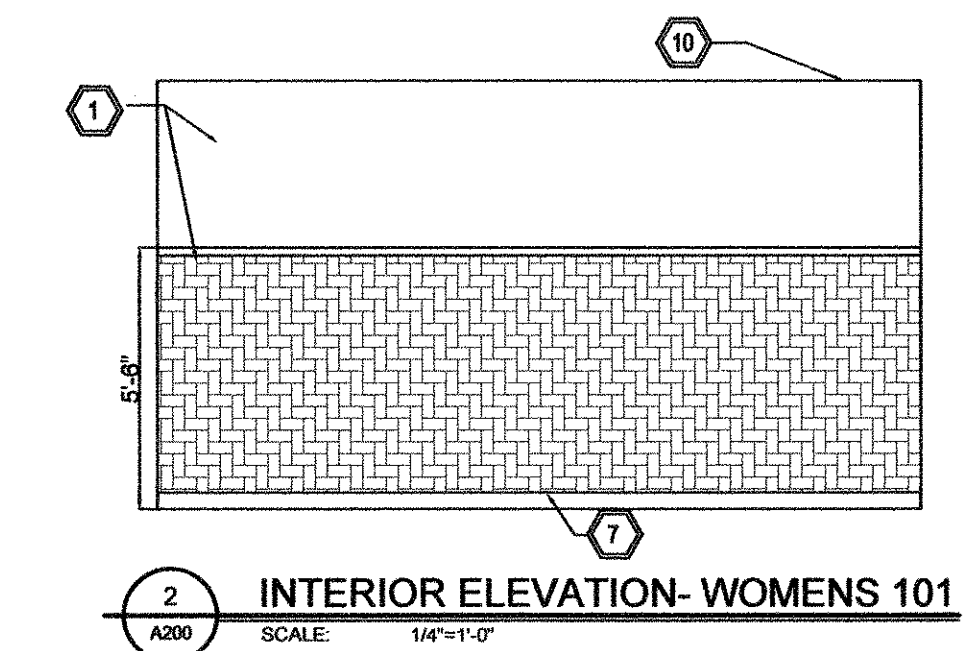


2 INTERIOR ELEVATION- WOMENS 101
SCALE: 1/4"=1'-0"

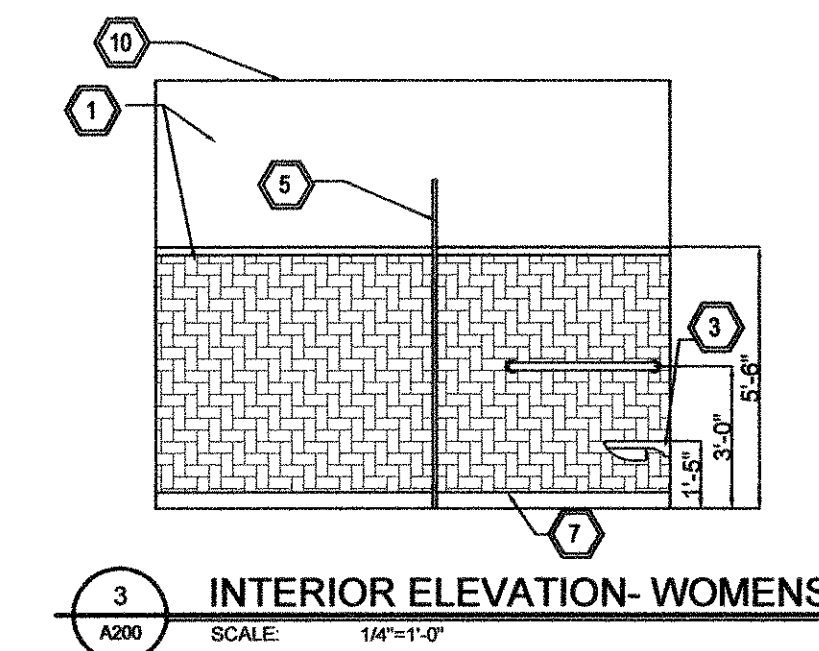


3 INTERIOR ELEVATION- WOMENS 101
SCALE: 1/4"=1'-0"

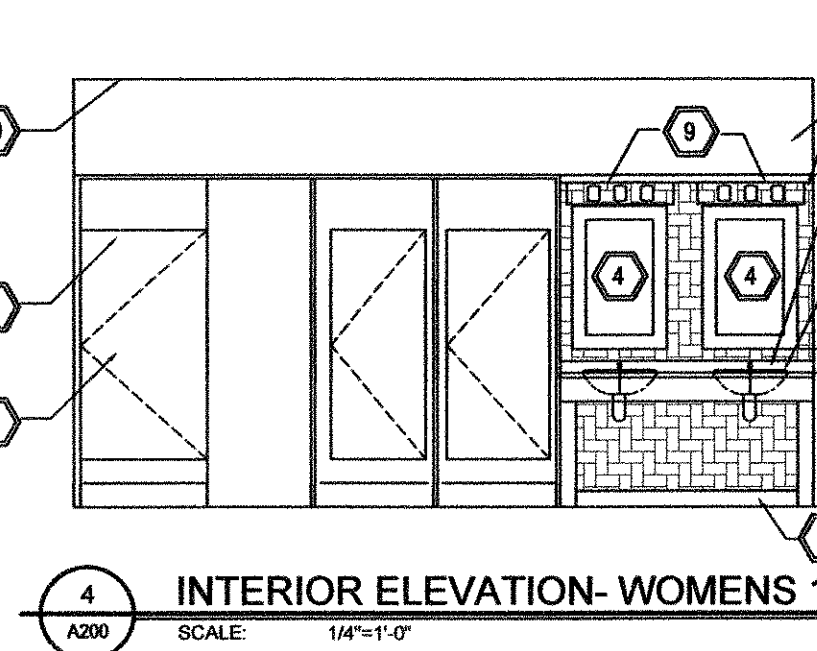


4 INTERIOR ELEVATION- WOMENS 101
SCALE: 1/4"=1'-0"

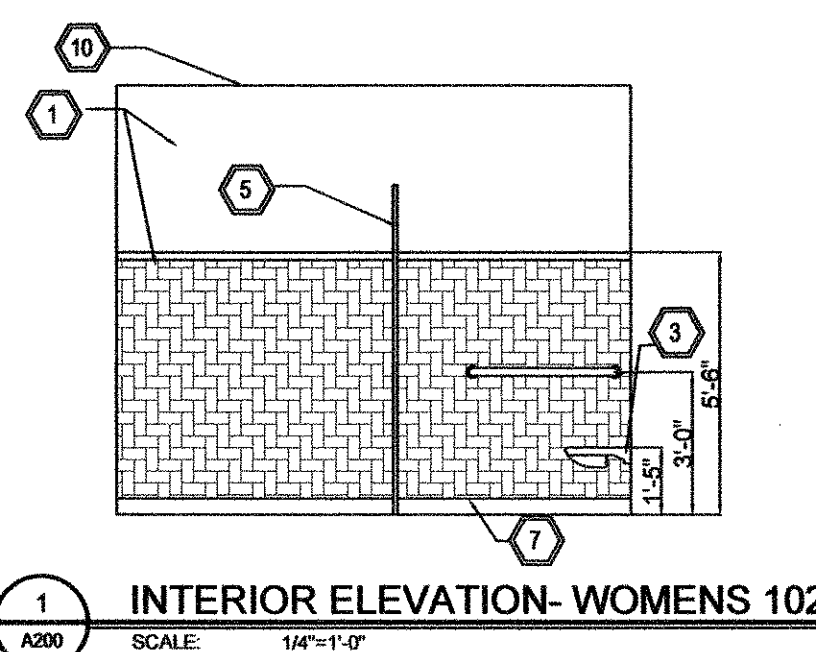


1 INTERIOR ELEVATION- WOMENS 102
SCALE: 1/4"=1'-0"

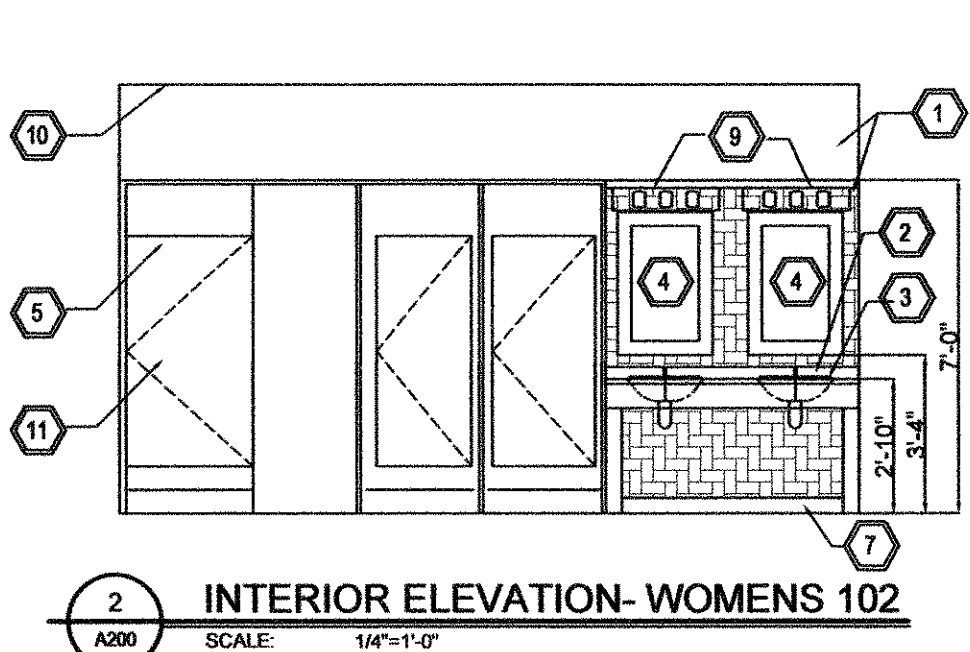


2 INTERIOR ELEVATION- WOMENS 102
SCALE: 1/4"=1'-0"

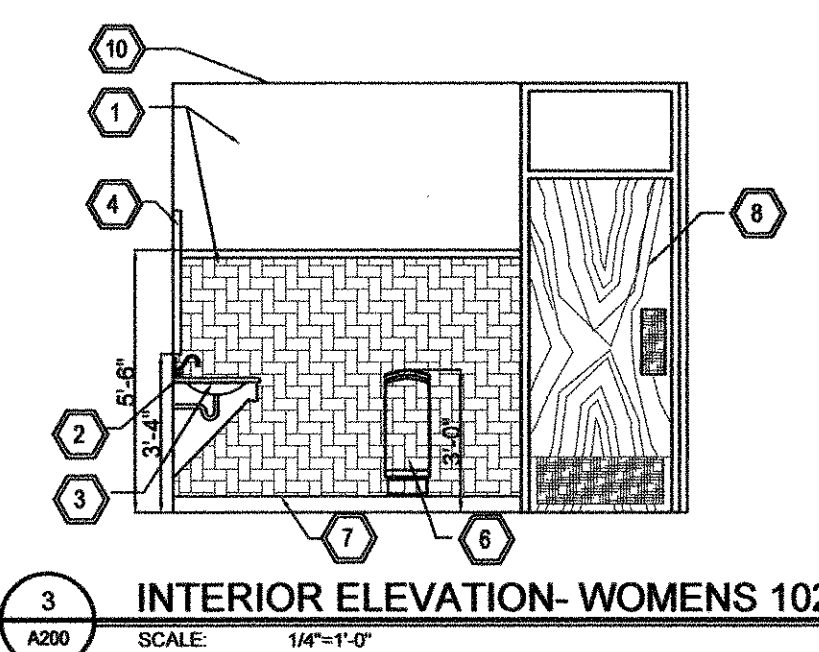


3 INTERIOR ELEVATION- WOMENS 102
SCALE: 1/4"=1'-0"

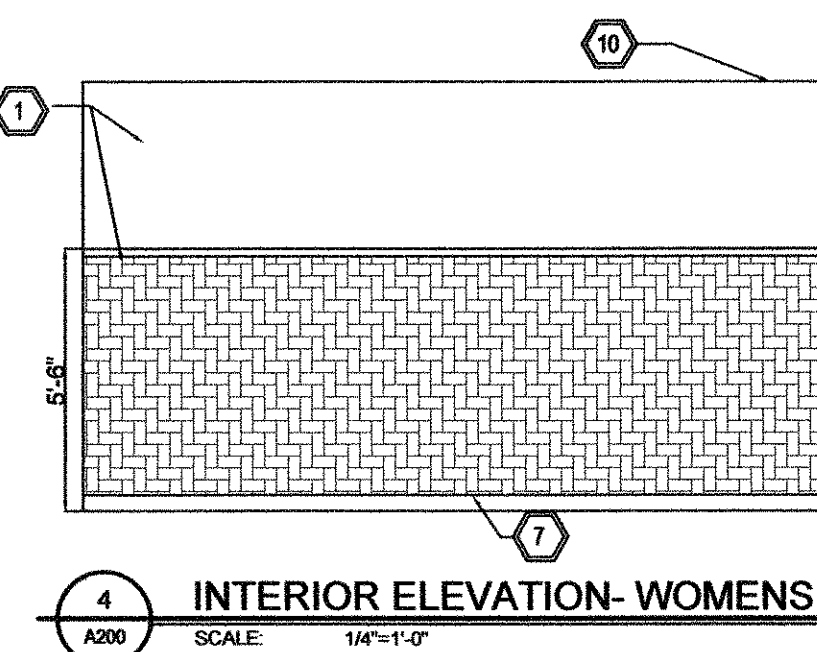


4 INTERIOR ELEVATION- WOMENS 102
SCALE: 1/4"=1'-0"

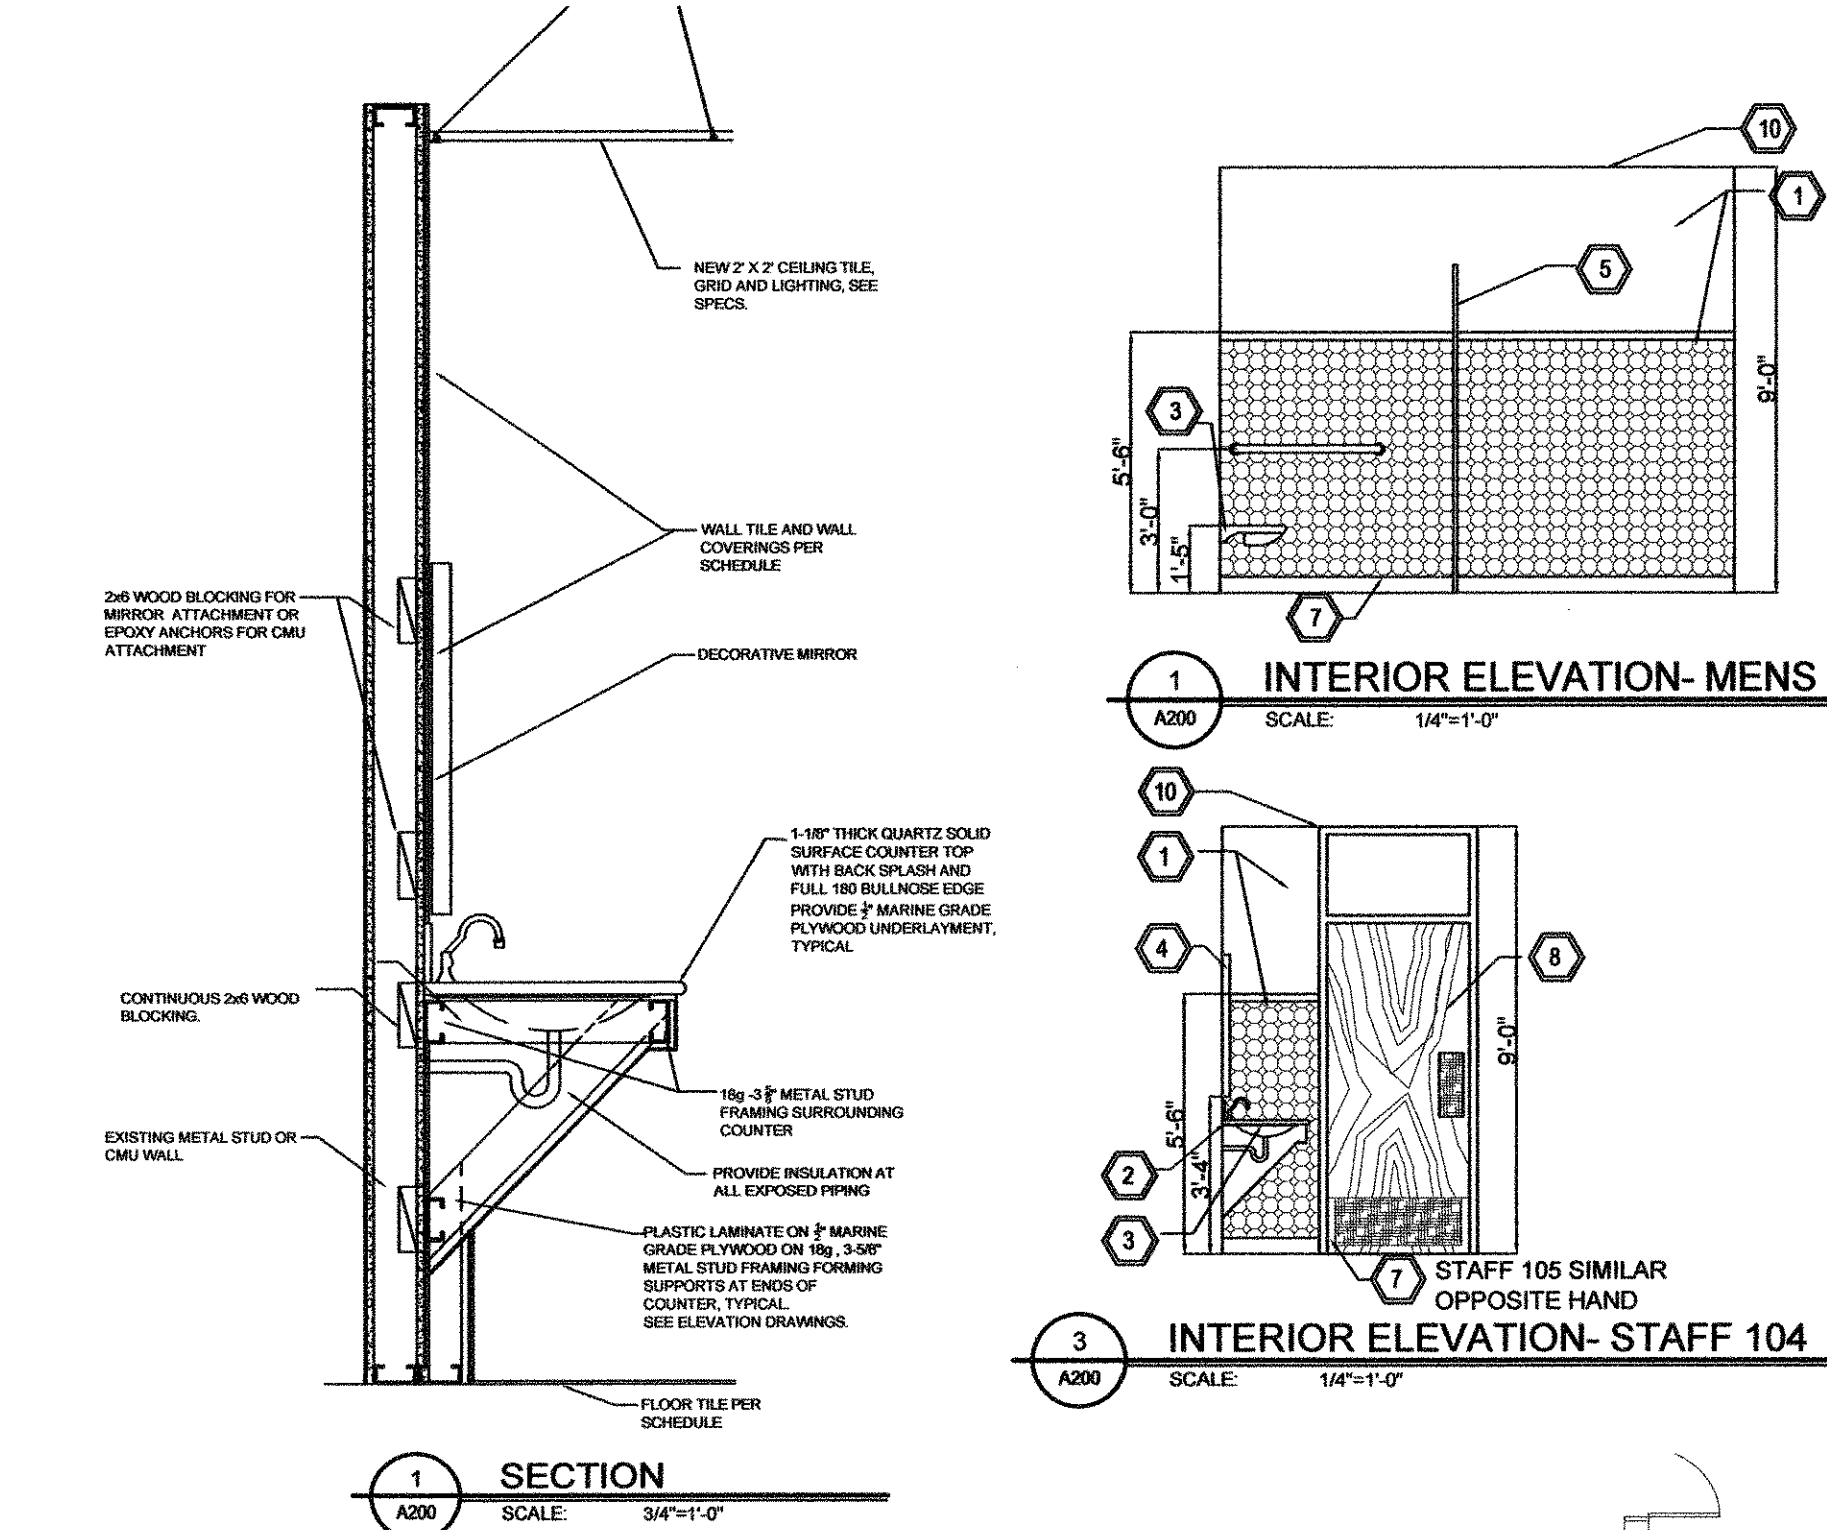


1 SECTION
SCALE: 3/4"=1'-0"

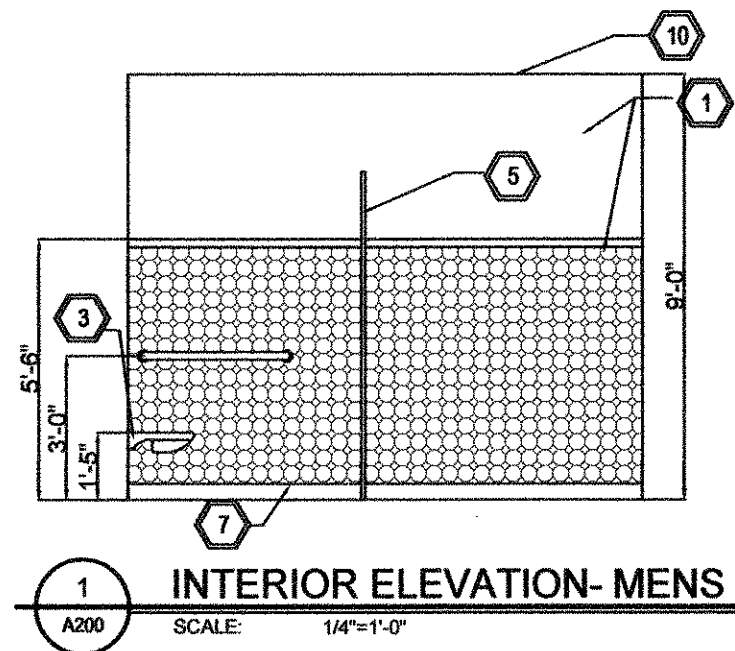


1 INTERIOR ELEVATION- MENS 103
SCALE: 1/4"=1'-0"

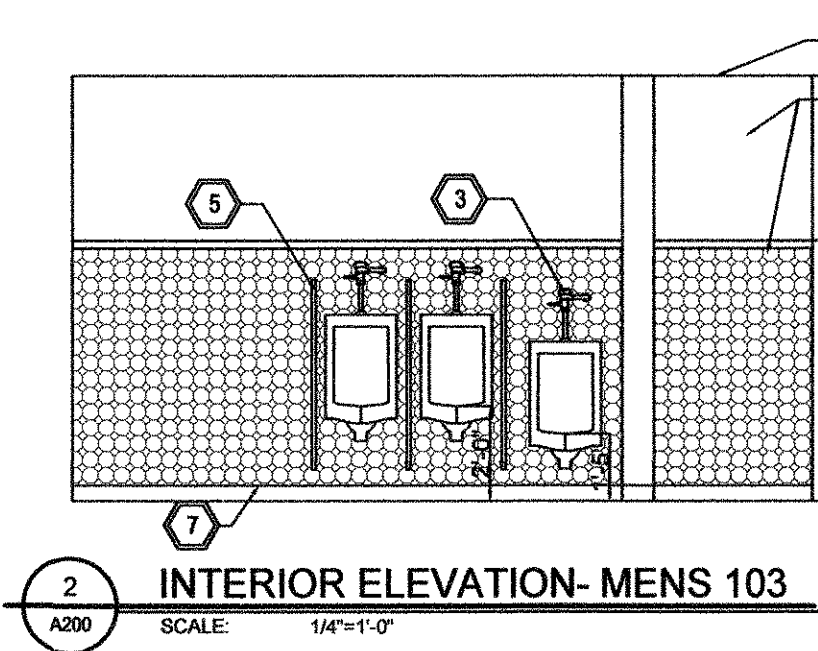


2 INTERIOR ELEVATION- MENS 103
SCALE: 1/4"=1'-0"

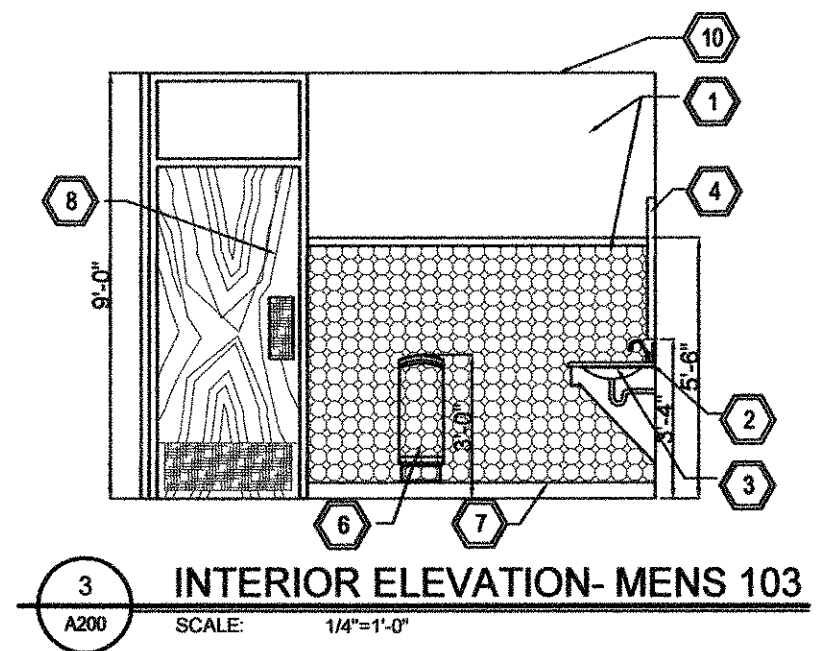


3 INTERIOR ELEVATION- MENS 103
SCALE: 1/4"=1'-0"

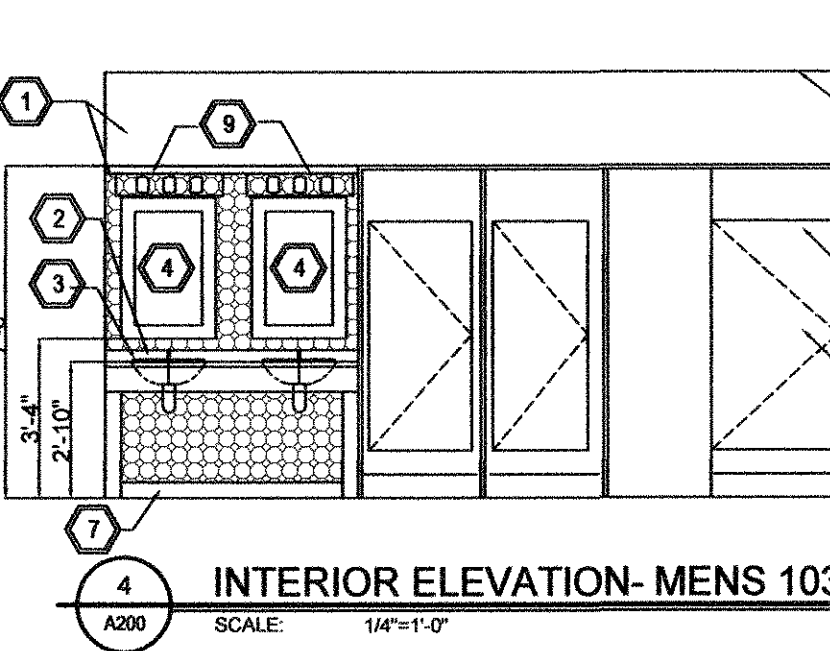

4 INTERIOR ELEVATION- MENS 103
SCALE: 1/4"=1'-0"

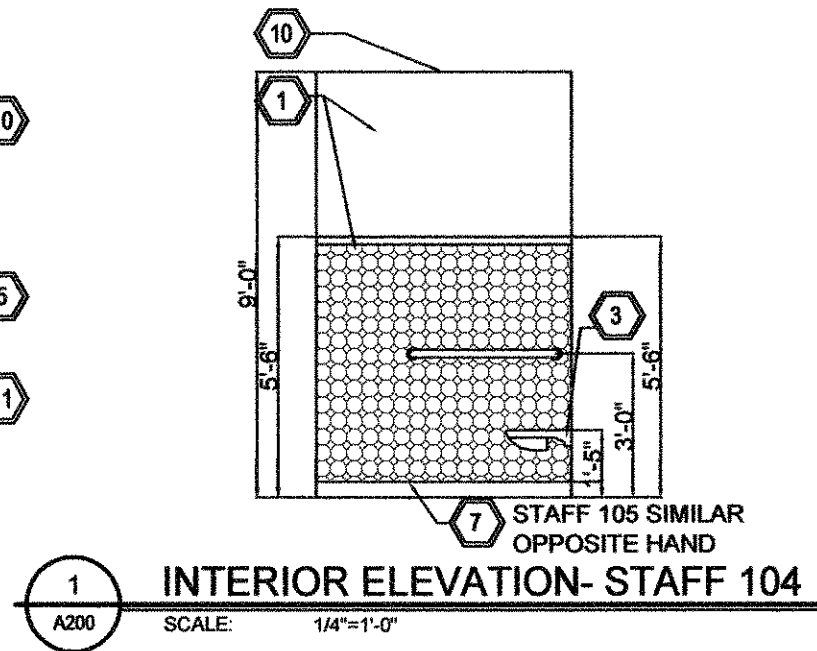

1 INTERIOR ELEVATION- STAFF 104
SCALE: 1/4"=1'-0"

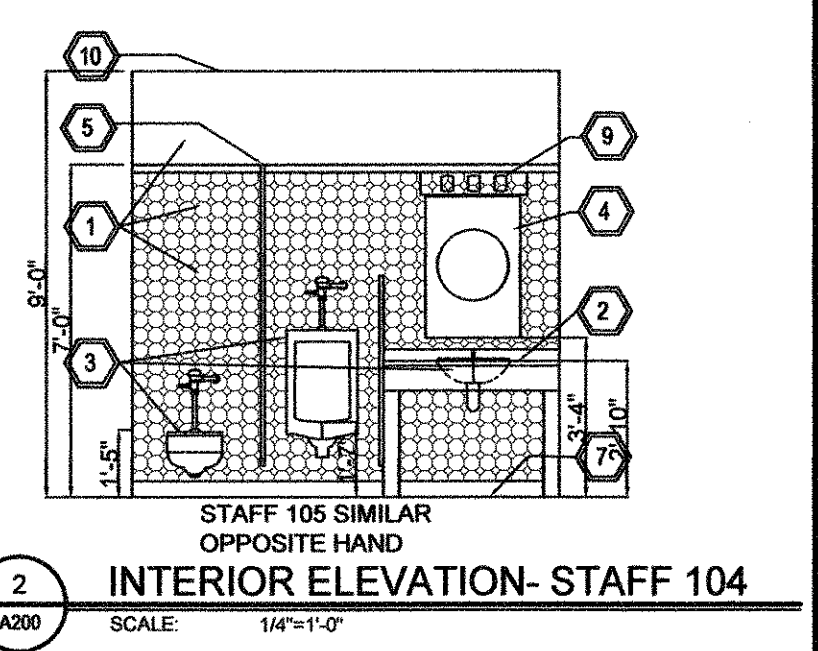

2 INTERIOR ELEVATION- STAFF 104
SCALE: 1/4"=1'-0"

SCOPE OF WORK IN THIS CONTRACT SHALL INCLUDE FIRST FLOOR RESTROOM RENOVATIONS IN BASE BID. PROVIDE ADD ALTERNATE #1 FOR SECOND FLOOR RESTROOM RENOVATIONS

KEYED NOTES:



- NEW WALL TILE WITH WALL COVERING ABOVE. PREP WALLS, REPAIR AS REQUIRED AFTER DEMOLITION TO ACCOMMODATE NEW INSTALLATIONS.
- NEW QUARTZ COUNTER TOP WITH MARINE GRADE PLYWOOD SUBSTRATE ON METAL STUD FRAMING. ANCHOR FRAMING TO WALLS AND SUPPORT KNEE BRACES, TYP. SEE SECTION ON A200.
- NEW TOILET ROOM FIXTURES TYPICAL. TOILETS, UNDERMOUNT LAVATORIES, AND WATERLESS URINALS. SEE PLUMBING AND DEMOLITION PLANS.
- NEW DECORATIVE MIRRORS, SECURELY ANCHOR TO CMU OR STUD WALL, TYPICAL.
- NEW TOILET PARTITIONS AND URINAL SCREENS, TYPICAL, PROVIDE SHOP DRAWINGS FOR REVIEW.
- NEW HAND DRYER, TYPICAL. SUBMIT SHOP DRAWINGS FOR REVIEW.
- NEW FLOOR TILE AND BASE, SLIP RESISTANT, ADJUST HEIGHT OF EXISTING FLOOR DRAINS TO ACCOMMODATE NEW FLOOR TILE.
- NEW SOLID CORE FACTORY FINISHED WOOD DOORS IN EXISTING METAL FRAME, TYPICAL. PROVIDE NEW HARDWARE FOR DOORS AS SCHEDULED. SUBMIT SHOP DRAWINGS FOR REVIEW.
- NEW DECORATIVE LIGHT FIXTURE ABOVE MIRRORS TO REPLACE EXISTING. PATCH AND REPAIR WALL AS REQUIRED TO ALLOW FOR INSTALLATION OF NEW FIXTURE.
- NEW CEILING AND LIGHTING AT SAME HEIGHT AS EXISTING CEILING AND LIGHTING TO BE REMOVED. 9'-0" AFF AT FIRST FLOOR, 8'-0" AFF AT SECOND FLOOR.
- EXTEND WALL TILE ON WALLS WITH TOILET PARTITIONS

WOMENS RESTROOM FINISHES

WALL COVERING: CONCERTEX - ZENDO TAHREA
 COLOR: ZT033 VISTA GREEN
 WALL TILE: DALTILE WALL TILE
 COLOR: ARCHITECTURAL GRAY
 COUNTER TOPS: DUPONT ZODIAQ
 COLOR: ASTRAL PEARL
 TOILET PARTITIONS: HADRIAN
 239 GRAY (SOLID PLASTIC)
 FLOOR TILE: DALTILE TIMBER GLEN
 COLOR: THATCH P615

MENS RESTROOM FINISHES


WALL COVERING: CONCERTEX - RAPHAELZTEC
 COLOR: CARAMEL
 WALL TILE: DALTILE WALL TILE
 COLOR: ALMOND
 COUNTER TOPS: DUPONT ZODIAQ
 COLOR: SAVORY
 TOILET PARTITIONS: HADRIAN
 259 MOCHA (SOLID PLASTIC)
 FLOOR TILE: DALTILE FABRIQUE
 COLOR: SOLEIL LINEN P887

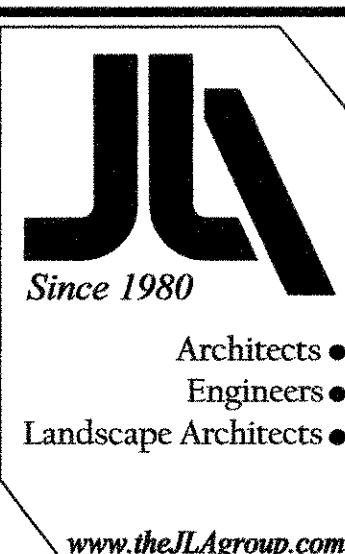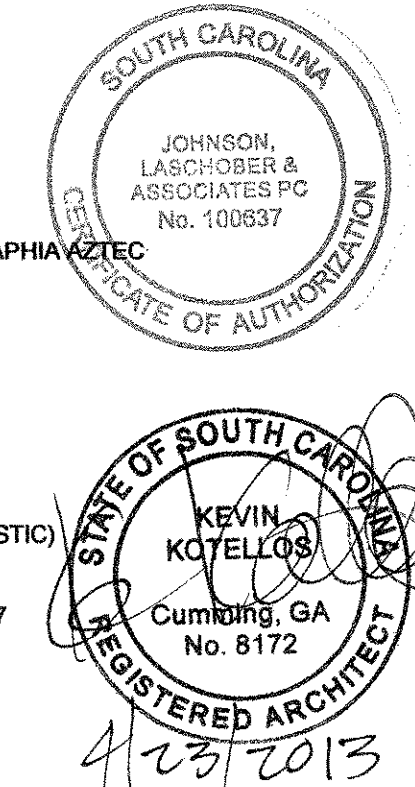

USC AIKEN
 AIKEN, SOUTH CAROLINA
PENLAND BUILDING RESTROOM RENOVATIONS
INTERIOR ELEVATIONS, SCHEDULES


JOHNSON, LASCHNER & ASSOCIATES, P.C.
 1296 BROAD STREET AUGUSTA, GEORGIA 30901
 TEL (706) 724-5756 FAX (706) 724-3955


SCALE	DATE	PROJECT NO.	DRAWING NO.	REV.
AS SHOWN	8/8/2012	6930.1202	A200	0

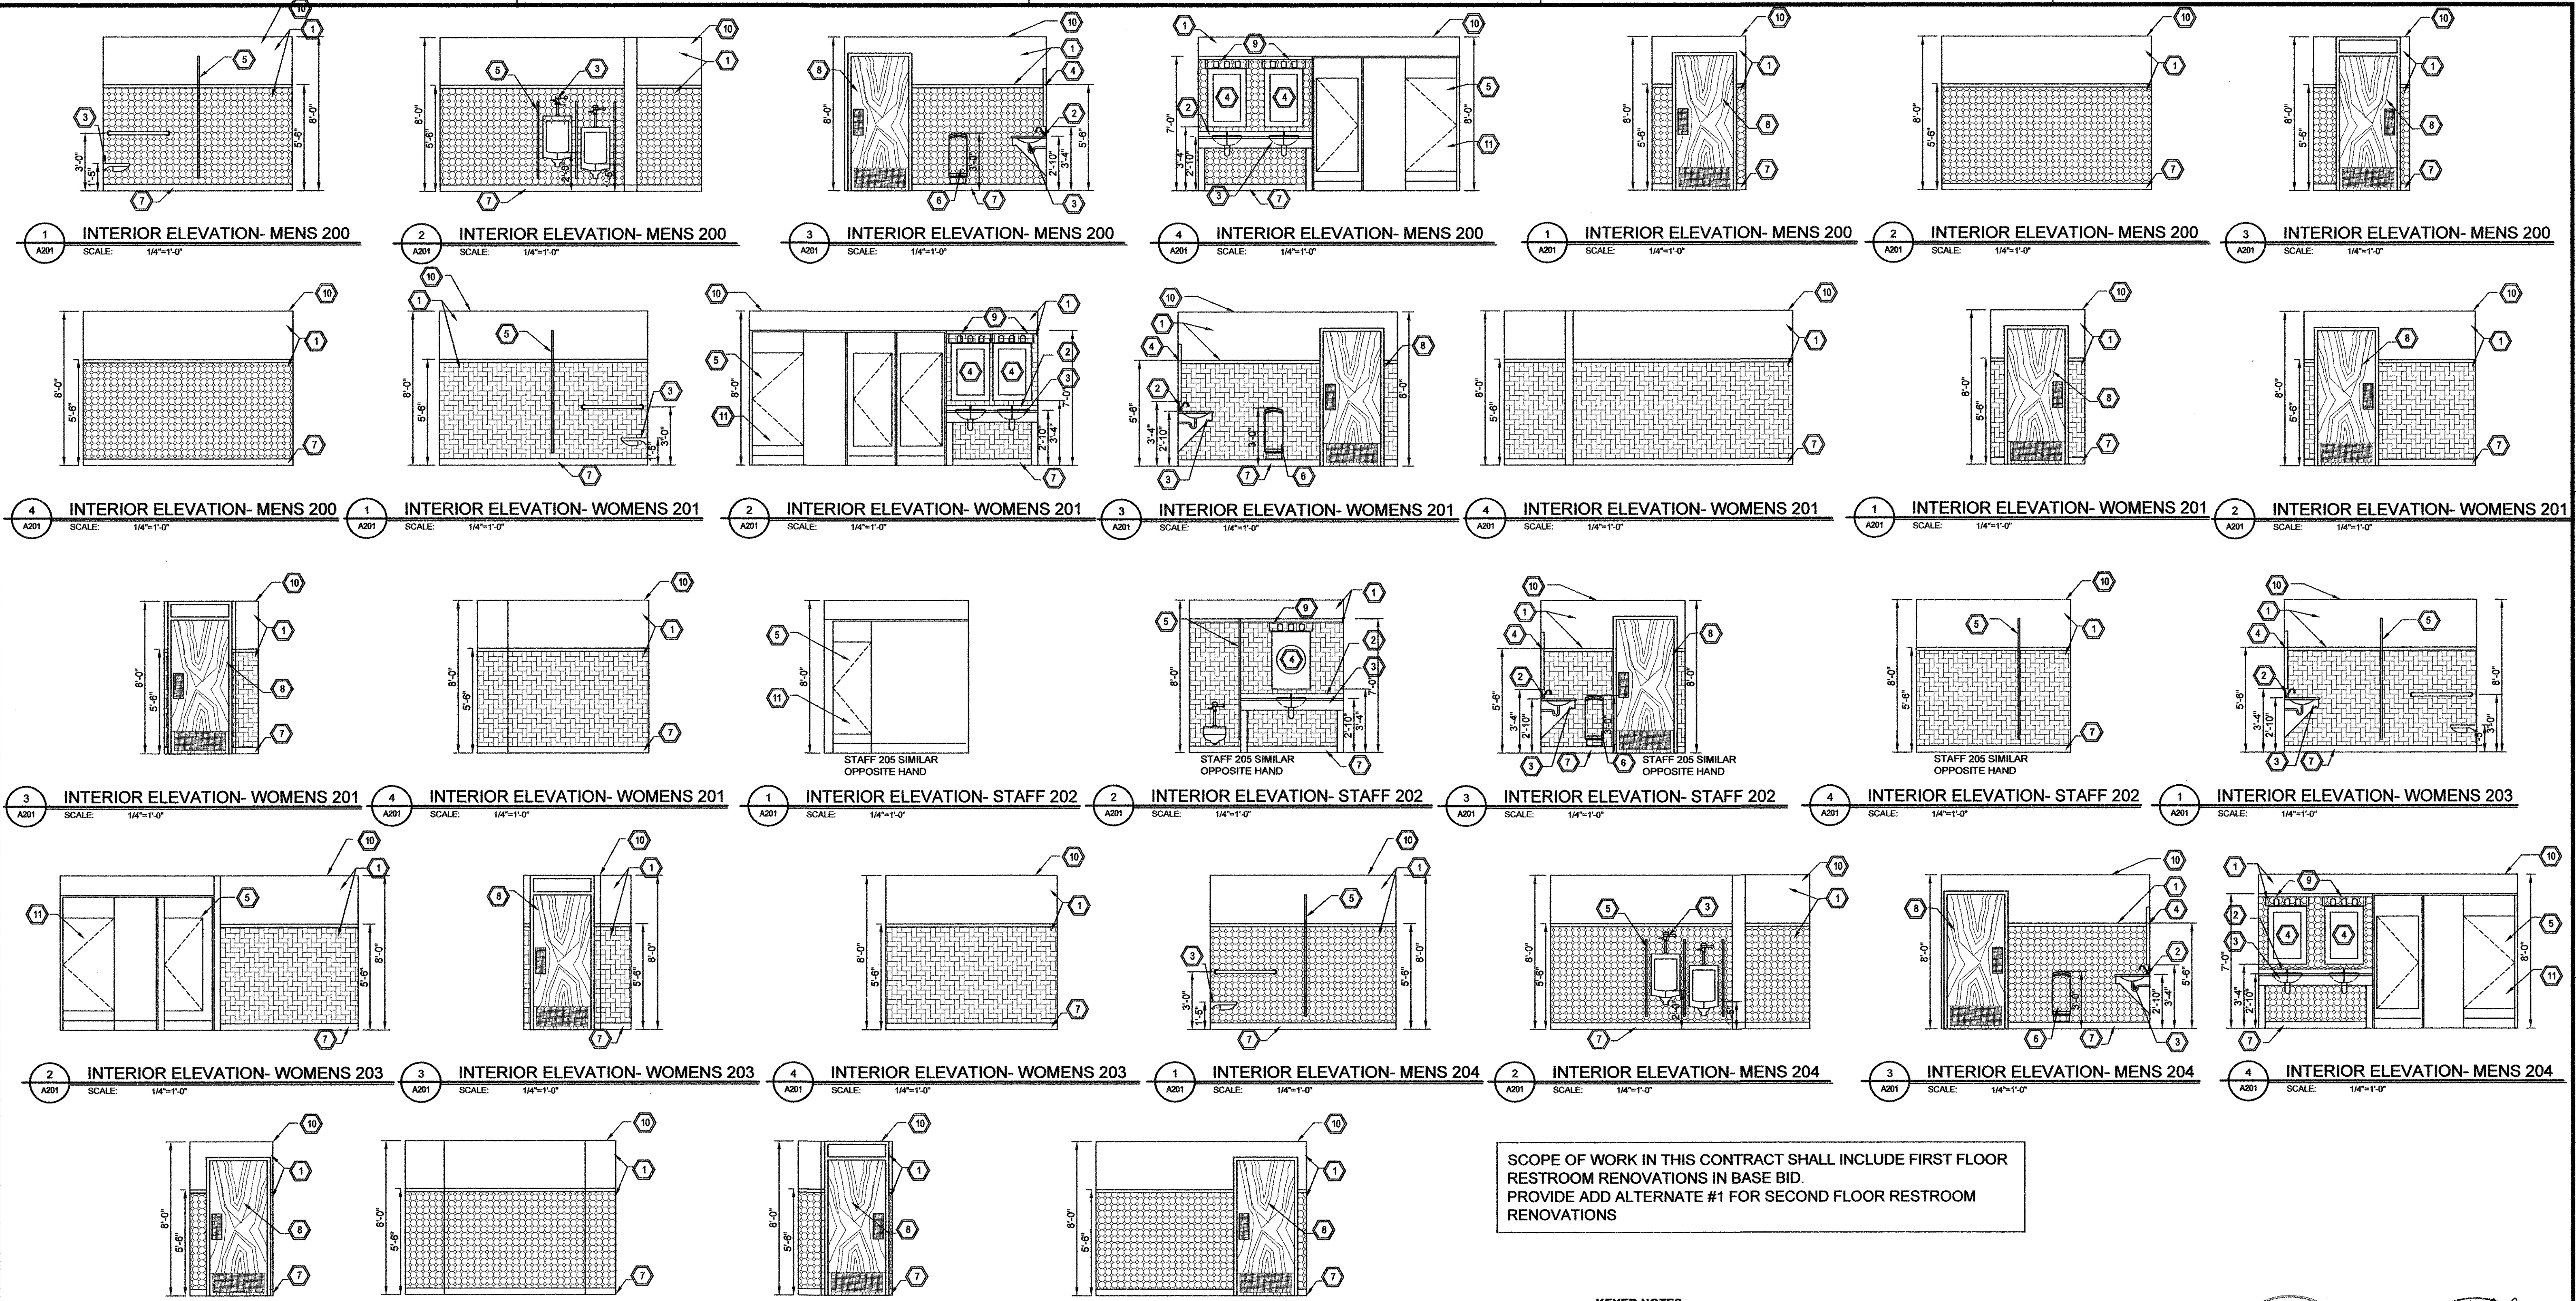


SCOPE OF WORK IN THIS CONTRACT SHALL INCLUDE FIRST FLOOR RESTROOM RENOVATIONS IN BASE BID.
PROVIDE ADD ALTERNATE #1 FOR SECOND FLOOR RESTROOM RENOVATIONS

- KEYED NOTES:**
- 1 NEW WALL TILE WITH WALL COVERING ABOVE. PREP WALLS, REPAIR AS REQUIRED AFTER DEMOLITION TO ACCOMMODATE NEW INSTALLATIONS.
 - 2 NEW QUARTZ COUNTER TOP WITH MARINE GRADE PLYWOOD SUBSTRATE ON METAL STUD FRAMING. ANCHOR FRAMING TO WALLS AND SUPPORT KNEE BRACES, TYP. SEE SECTION ON A200.
 - 3 NEW TOILET ROOM FIXTURES TYPICAL, TOILETS, UNDERMOUNT LAVATORIES, AND WATERLESS URINALS. SEE PLUMBING AND DEMOLITION PLANS.
 - 4 NEW DECORATIVE MIRRORS, SECURELY ANCHOR TO CMU OR STUD WALL, TYPICAL.
 - 5 NEW TOILET PARTITIONS AND URINAL SCREENS, TYPICAL, PROVIDE SHOP DRAWINGS FOR REVIEW.
 - 6 NEW HAND DRYER, TYPICAL. SUBMIT SHOP DRAWINGS FOR REVIEW.
 - 7 NEW FLOOR TILE AND BASE, SLIP RESISTANT, ADJUST HEIGHT OF EXISTING FLOOR DRAINS TO ACCOMMODATE NEW FLOOR TILE.
 - 8 NEW SOLID CORE FACTORY FINISHED WOOD DOORS IN EXISTING METAL FRAME, TYPICAL. PROVIDE NEW HARDWARE FOR DOORS AS SCHEDULED. SUBMIT SHOP DRAWINGS FOR REVIEW.
 - 9 NEW DECORATIVE LIGHT FIXTURE ABOVE MIRRORS TO REPLACE EXISTING. PATCH AND REPAIR WALL AS REQUIRED TO ALLOW FOR INSTALLATION OF NEW FIXTURE.
 - 10 NEW CEILING AND LIGHTING AT SAME HEIGHT AS EXISTING CEILING AND LIGHTING TO BE REMOVED. 9'-0" AFF AT FIRST FLOOR, 8'-0" AFF AT SECOND FLOOR.
 - 11 EXTEND WALL TILE ON WALLS WITH TOILET PARTITIONS

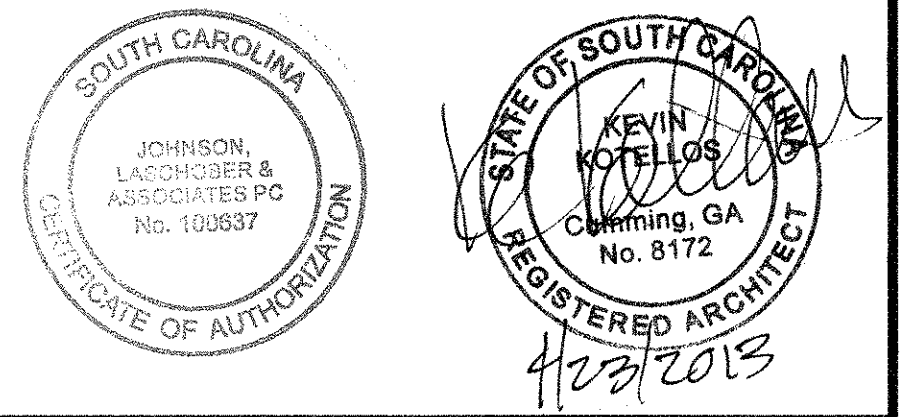

 Since 1980 Architects Engineers Landscape Architects www.theJLAgroup.com	USC AIKEN AIKEN, SOUTH CAROLINA				
	PENLAND BUILDING RESTROOM RENOVATIONS INTERIOR ELEVATIONS				
	JOHNSON, LASCHOB & ASSOCIATES, P.C. 1296 BROAD STREET TEL (706) 724-5756 AUGUSTA, GEORGIA 30901 FAX (706) 724-3955				
	SCALE AS SHOWN	DATE 8/8/2012	PROJECT NO. 6930.1202	DRAWING NO. A201	REV. 0

0	04/22/2013	KK	ISSUED FOR BID
REV	DATE	BY	DESCRIPTION
REVISIONS			
DRAWN BY: NKM		DATE: 8/8/2012	CHECKED BY: KK DATE: 8/8/2012

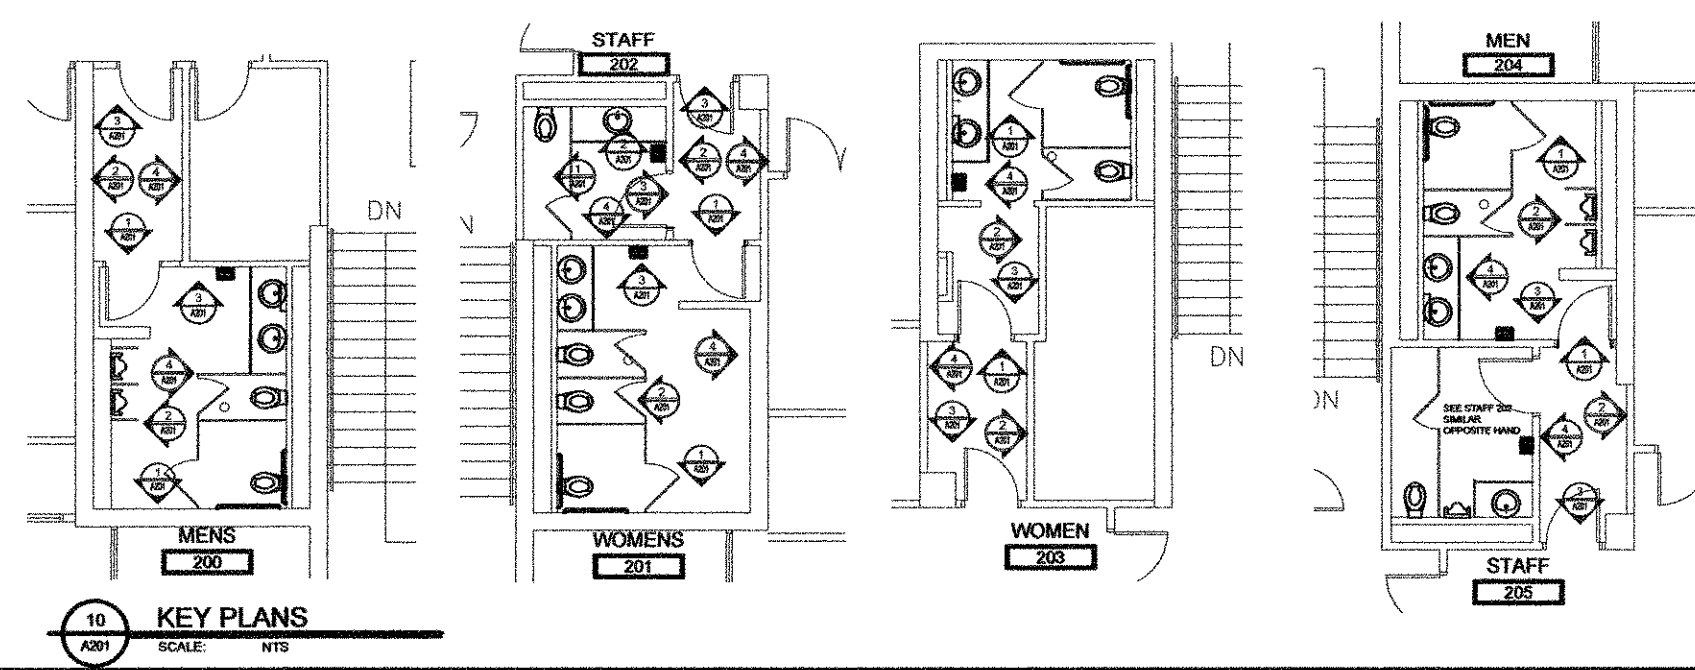

C:\JLA\2013\DWG REV 10/27/07 DSE

CEILING HT. EL. 8'-0" @2ND FLR. 9'-0" AT 1ST FLR

EL. +40"

FIN. FLOOR

4"C.T. BASE

RESTROOM ELEVATIONS

SCALE: 1/4" = 1'-0"

EXPOSED PIPES AND SURFACES OF HOT WATER AND DRAIN PIPES UNDER LAVATORIES SHALL BE INSULATED OR OTHERWISE CONFIGURED TO PROTECT AGAINST CONTACT. THERE SHALL BE NO SHARP OR ABRASIVE SURFACES UNDER LAVATORIES. RULE 120-3-20-.30(4) GEORGIA ACCESSIBILITY CODE.

SIGNAGE FOR RESTROOMS SHALL BE RAISED AND BRAILLE CHARACTERS AND PICTORIAL SYMBOL SIGNS. SIGNS SHALL BE INSTALLED ON THE WALL ADJACENT TO THE LATCH SIDE OF THE DOOR. WHERE THERE IS NO WALL SPACE TO THE LATCH SIDE OF THE DOOR, INCLUDING AT DOUBLE LEAF DOORS, SIGNS SHALL BE PLACED ON THE NEAREST ADJACENT WALL. MOUNTING HEIGHT SHALL BE 60" A.F.F. TO THE CENTERLINE OF THE SIGN. 120-3-20-.41(4),(5),(6) GEORGIA ACCESSIBILITY CODE.

TOILET ACCESSORIES SCHEDULE

MARK	DESCRIPTION	BRADLEY NUMBER
TA1	TOILET PAPER DUAL ROLL	5224
TA2	SANITARY NAPKIN DISPOSAL	4781-15
TA3	SOAP DISPENSER	6542
TA4	HAND DRYER	MITSUBISHI ELECTRIC CORP. JET TOWEL HAND DRYER JT-SB116EH-G-UL
TA5	FIXED MIRROR	DECORATIVE MIRROR *
TA6	ADA COMPLIANT SIGN OF ACCESSIBILITY	
TA7	GRAB BAR (S.S.)	812-4-001

S.S. - #4 SATIN FINISH STAINLESS STEEL

* DECORATIVE MIRRORS BY classymirrors.com
PROVIDE 14" NATURAL WOOD MIRRORS, 24 X 36, ITEM NUMBER
JES 2010 FOR ALL PUBLIC RESTROOMS
PROVIDE 4" STENNIS WOOD MIRRORS, 24 X 36, ITEM NUMBER
JES 2012 FOR STAFF RESTROOMS
PROVIDE SECURE MOUNTING HARDWARE FOR MOUNTING IN
GYP BD STUD WALL OR CMU WALL, TYPICAL.

PER ADA AND ANSI 117.1

RAISED AND BRAILLE CHARACTERS AND PICTORIAL SYMBOL SIGNS:


LETTERS AND NUMERALS SHALL BE RAISED 1/32 INCH, UPPERCASE, SANS SERIF OR SIMPLE SERIF TYPE AND SHALL BE ACCOMPANIED WITH GRADE 2 BRAILLE. RAISED CHARACTERS SHALL BE AT LEAST 5/8 INCH (16MM) HIGH, BUT NO HIGHER THAN 2 INCHES (50 MM). PICTOGRAMS SHALL BE ACCOMPANIED BY THE EQUIVALENT VERBAL DESCRIPTION PLACED DIRECTLY BELOW THE PICTOGRAM. THE BORDER DIMENSION OF THE PICTOGRAM SHALL BE 6 INCHES (152 MM) MINIMUM HEIGHT.

FINISH AND CONTRAST:

THE CHARACTERS AND BACKGROUND OF SIGNS SHALL BE EGGSHELL, MATTE, OR OTHER NON GLARE FINISH. CHARACTERS AND SYMBOLS SHALL CONTRAST WITH THEIR BACKGROUND - EITHER LIGHT CHARACTERS ON A DARK BACKGROUND OR DARK CHARACTERS ON A LIGHT BACKGROUND.

MOUNTING AND LOCATION HEIGHT:

WHERE PERMANENT IDENTIFICATION IS PROVIDED FOR ROOMS AND SPACES, SIGNS SHALL BE INSTALLED ON THE WALL ADJACENT TO THE LATCH SIDE OF THE DOOR. WHERE THERE IS NO WALL SPACE TO THE LATCH SIDE OF THE DOOR, INCLUDING DOUBLE LEAF DOORS, SIGNS SHALL BE PLACED ON THE NEAREST ADJACENT WALL. MOUNTING HEIGHT SHALL BE 60 INCHES (1525 MM) ABOVE THE FINISH FLOOR TO THE CENTERLINE OF THE SIGN. MOUNTING LOCATION FOR SUCH SIGNAGE SHALL BE SO THAT A PERSON MAY APPROACH WITHIN 3 INCHES (76 MM) OF SIGNAGE WITHOUT ENCOUNTERING PROTRUDING OBJECTS OR STANDING WITHIN THE SWING OF A DOOR.

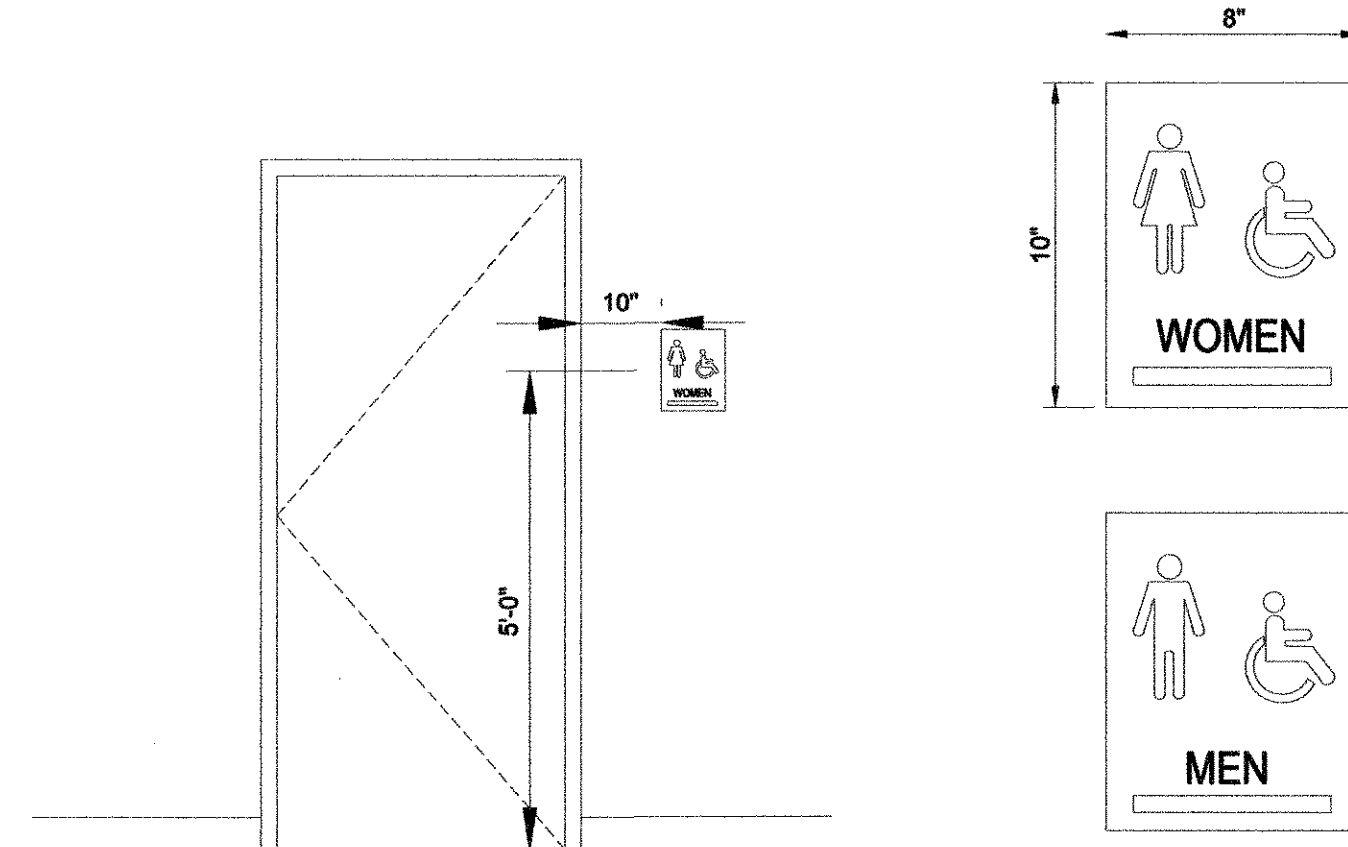


SIGN CHARACTERS & BACKGROUND SHALL BE EGGSHELL, MATTE, OR OTHER NON-GLARE FINISH.

PROVIDE WHITE LETTERS & CHARACTERS ON BROWN BACKGROUND FOR CONTRAST AS REQ'D BY ADA.

LETTERS & NUMBERS SHALL BE 1" HIGH UPPER CASE SANS SERIF OR SIMPLE SERIF FONT, RAISED 1/32" & SHALL BE ACCOMPANIED BY GRADE 2 BRAILLE.

NOTES:

1. PROVIDE (1) SIGN AT EACH TOILET ROOM (STAFF), (MEN) AND (WOMEN), RESTROOM
2. ATTACH SIGN USING (4) FOUR FLATHEAD WOOD SCREWS, COUNTERSUNK, & ADHESIVE.

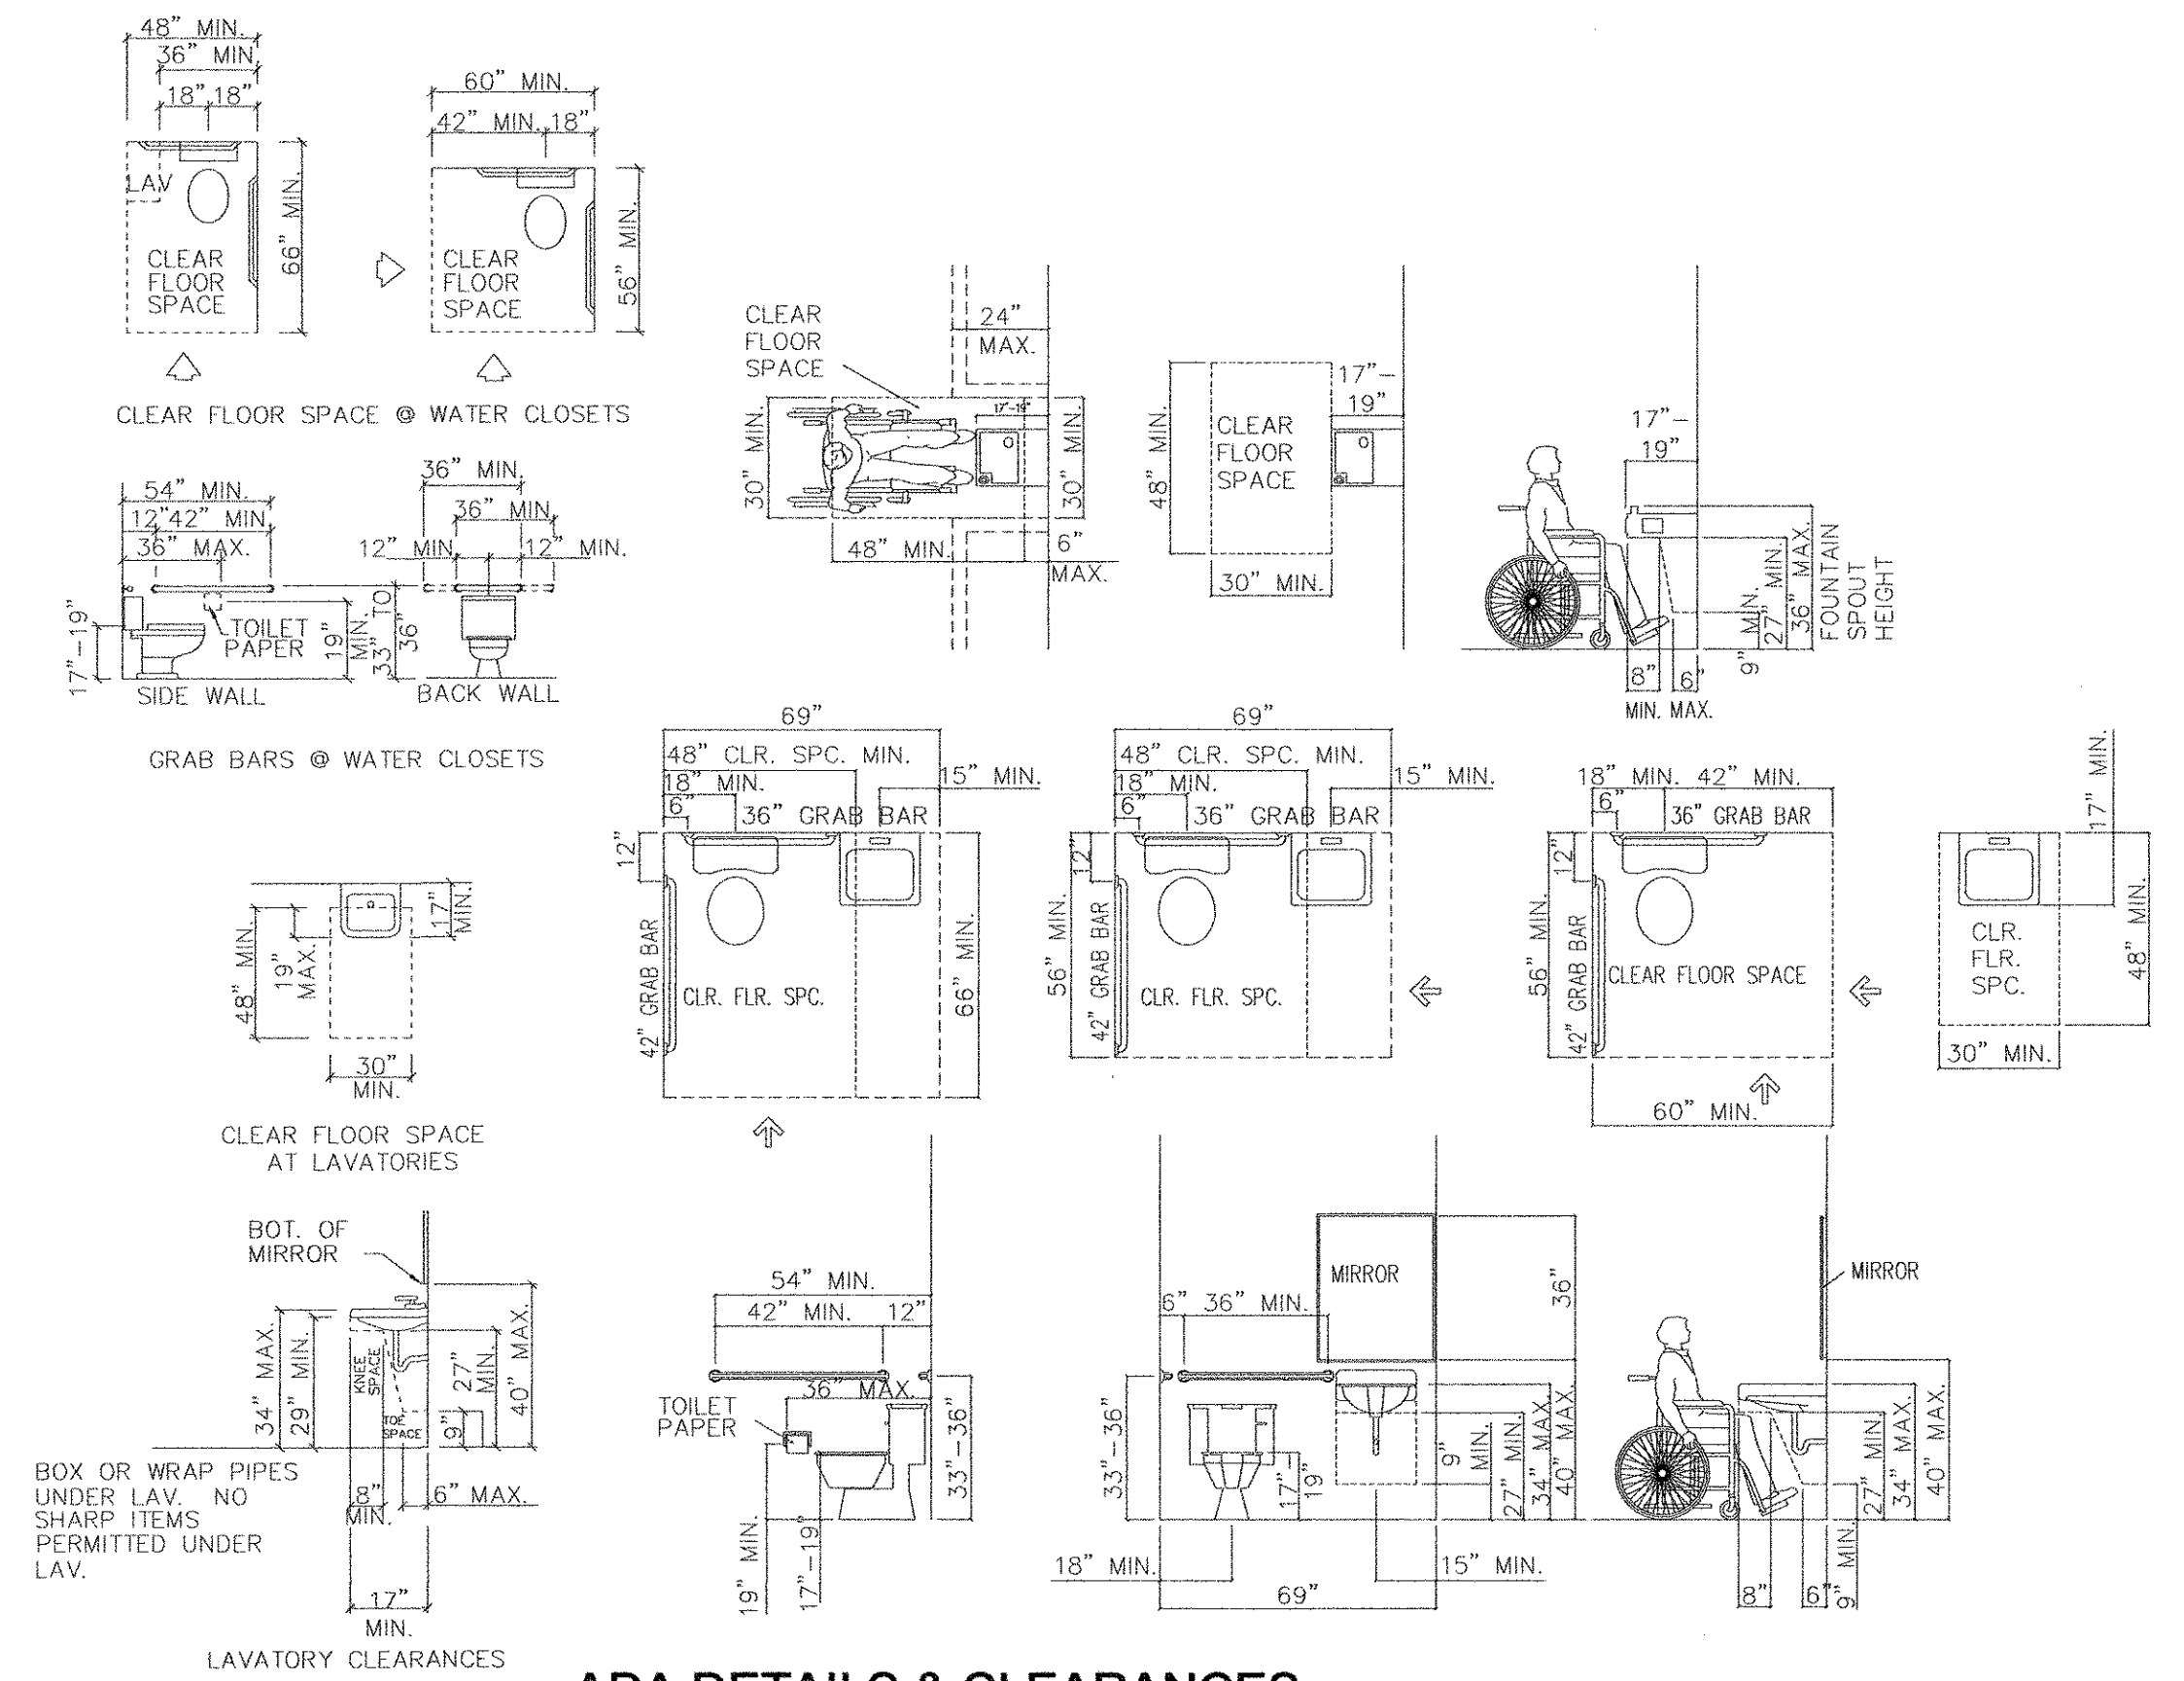


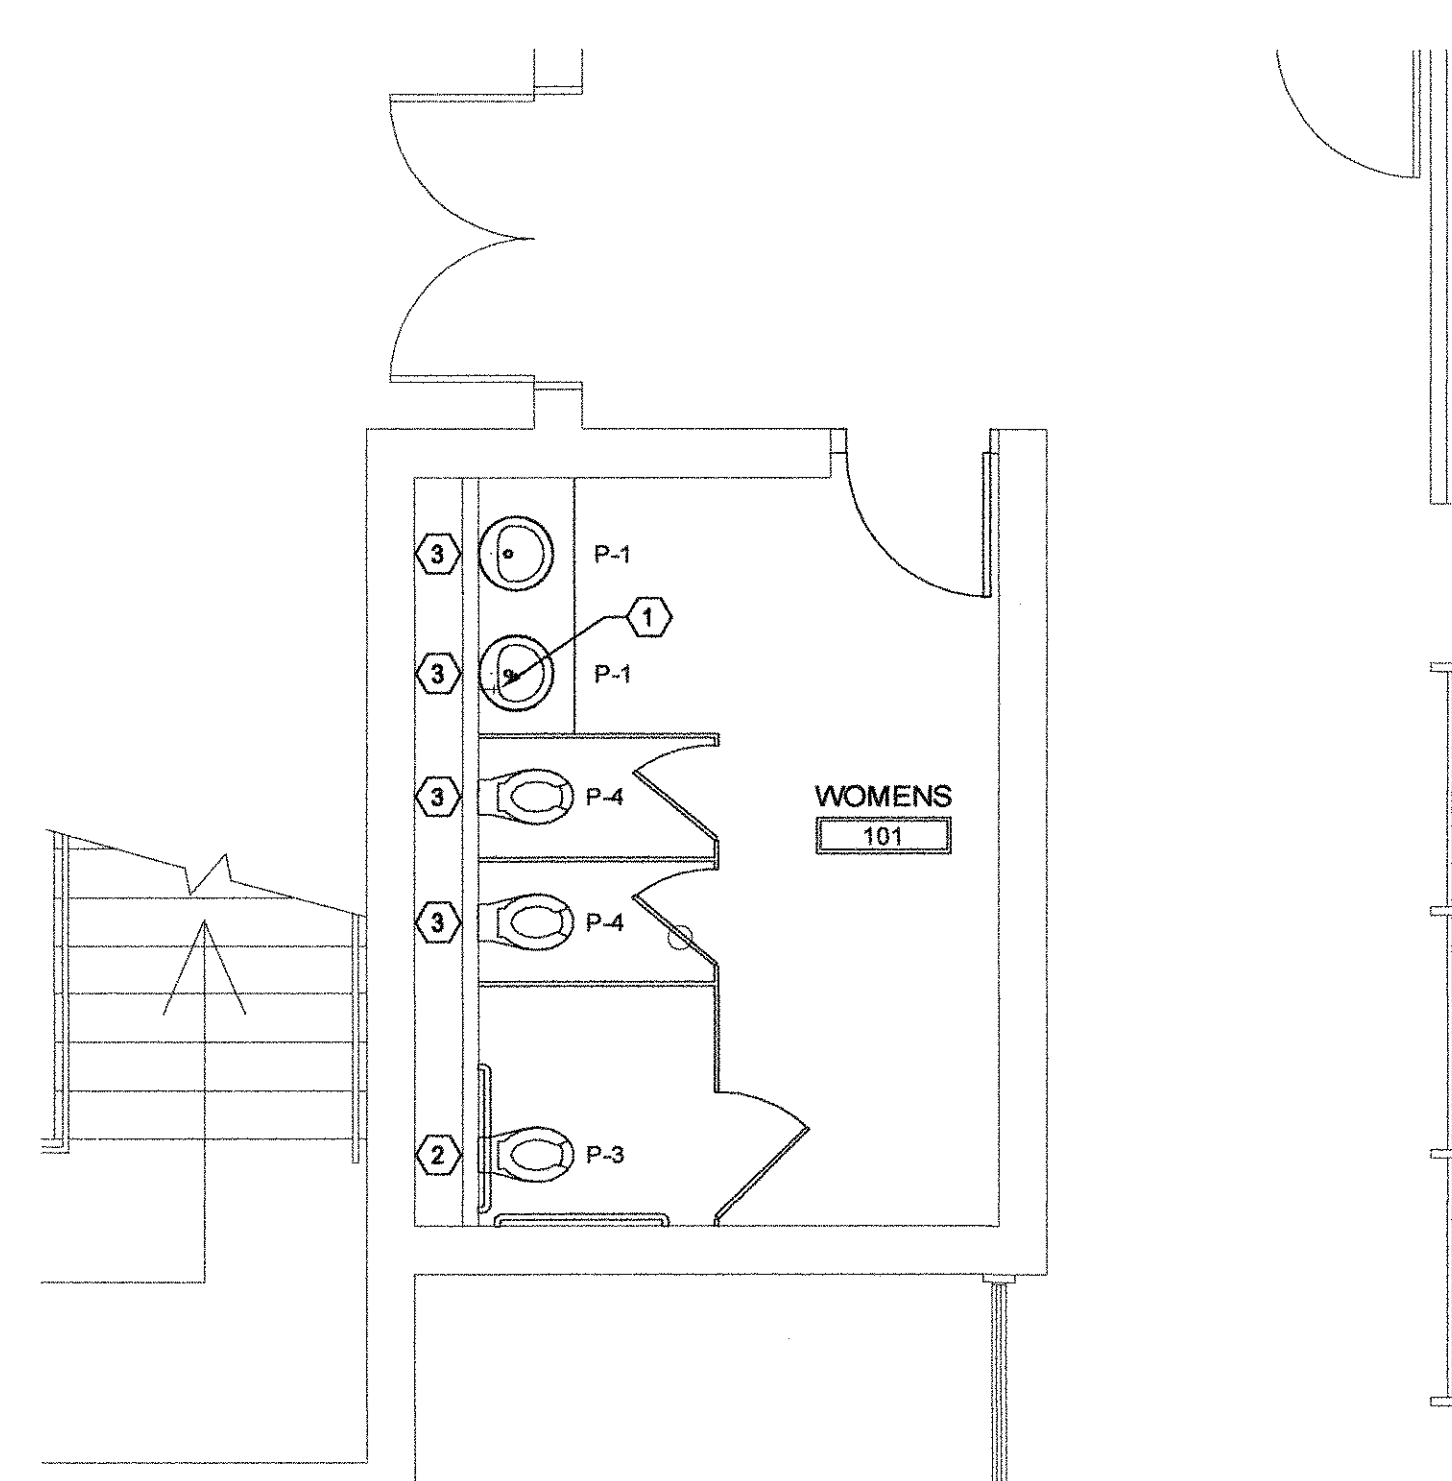
ADA DETAILS & CLEARANCES

NO SCALE


SCOPE OF WORK IN THIS CONTRACT SHALL INCLUDE FIRST FLOOR RESTROOM RENOVATIONS IN BASE BID. PROVIDE ADD ALTERNATE #1 FOR SECOND FLOOR RESTROOM RENOVATIONS

REV	DATE	BY	DESCRIPTION
0	4/22/2013	KK	ISSUED FOR BID
REVISIONS			
DRAWN BY: NKM DATE: 8/8/2012 CHECKED BY: KK DATE: 8/8/2012			


 Since 1980 Architects • Engineers • Landscape Architects • www.theJLAgroup.com	USC AIKEN AIKEN, SOUTH CAROLINA				
	PENLAND BUILDING RESTROOM RENOVATIONS				
	ADA DETAILS				
	JOHNSON, LASCHOVER & ASSOCIATES, P.C. 1296 BROAD STREET AUGUSTA, GEORGIA 30901 TEL (706) 724-5756 FAX (706) 724-3955				
SCALE	DATE	PROJECT NO.	DRAWING NO.	REV.	
SCALE	8/8/2012	6930.1202	A401	0	




PLUMBING PLAN
WOMEN'S TOILET - NORTH
0 5 1 2 4 8 12 FT.
SCALE: 1/4"=1'-0"

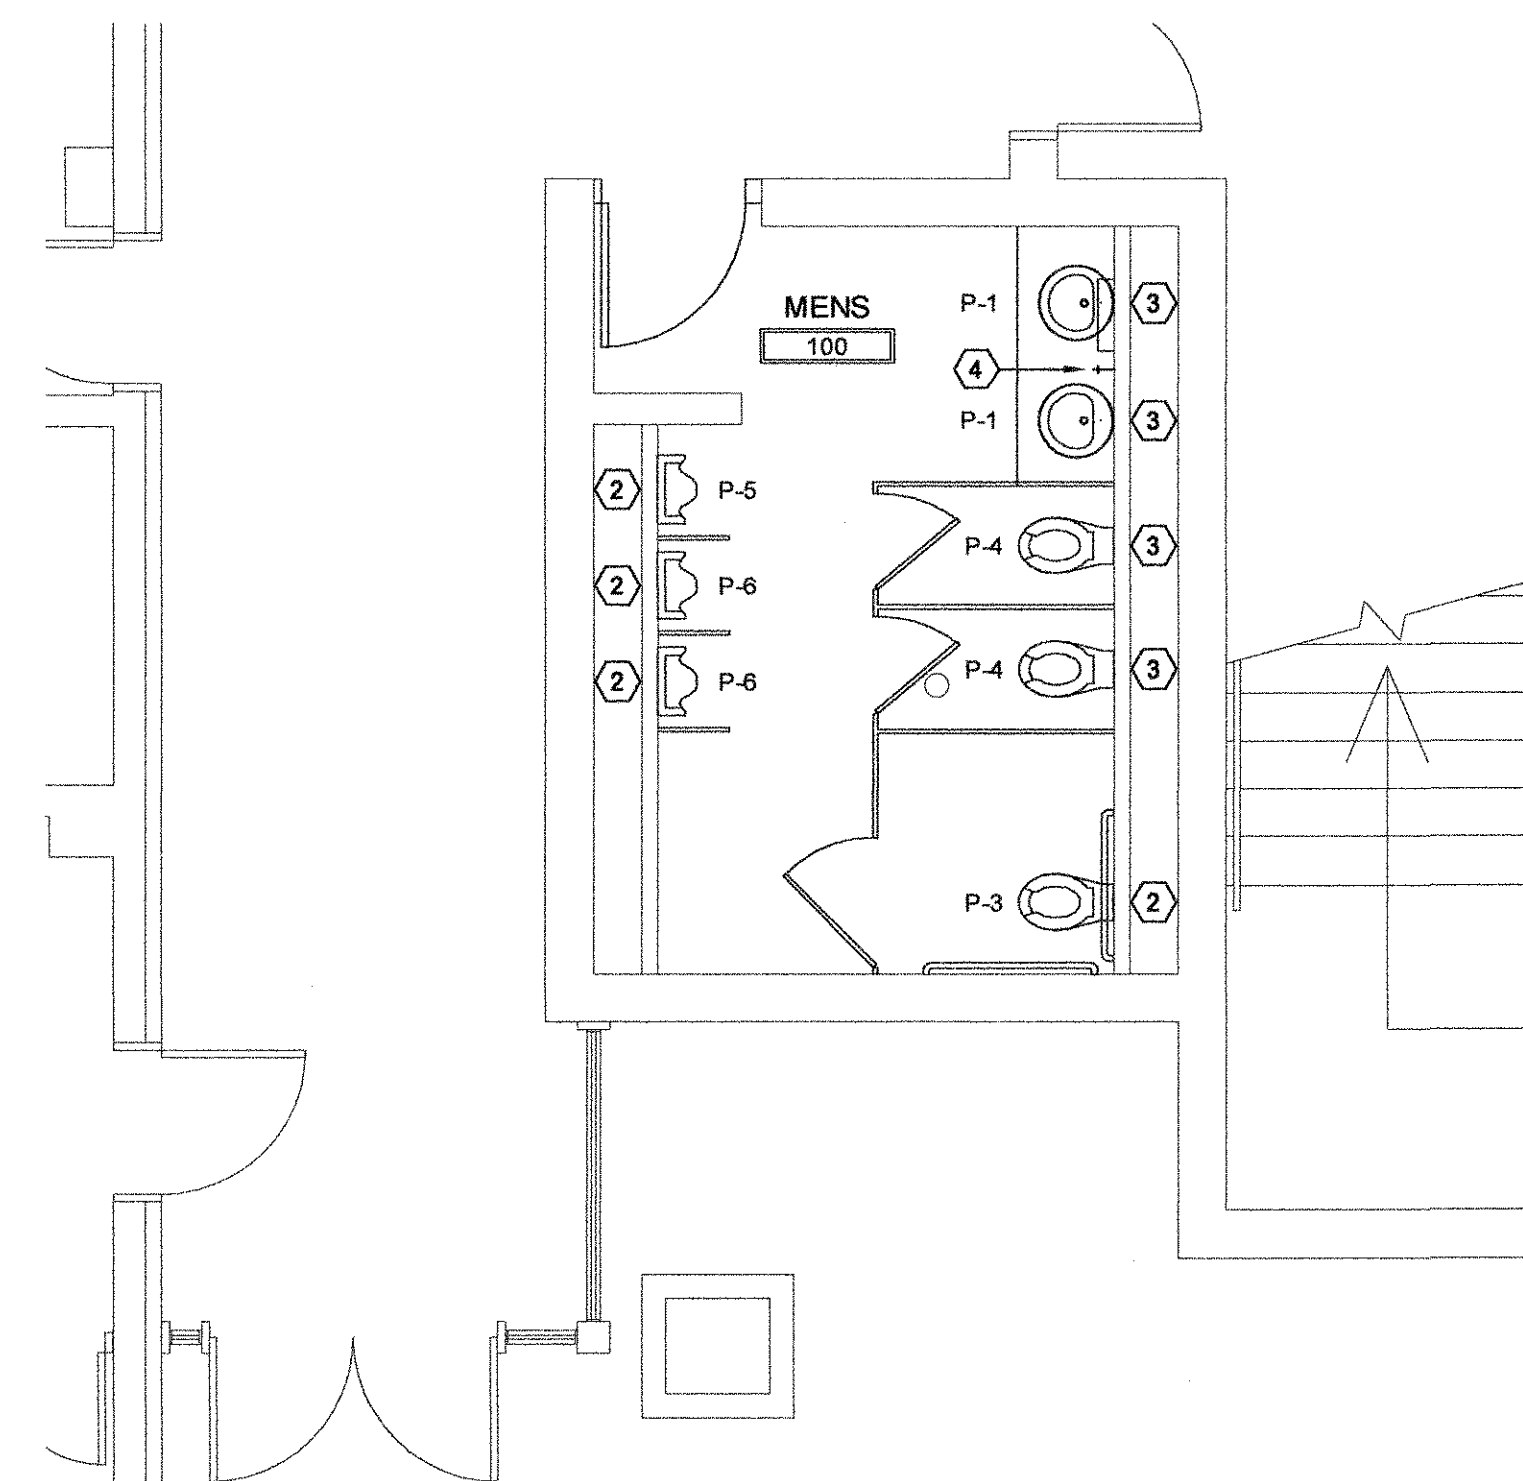


PLUMBING PLAN
MEN'S TOILET - NORTH
0 5 1 2 4 8 12 FT.
SCALE: 1/4"=1'-0"

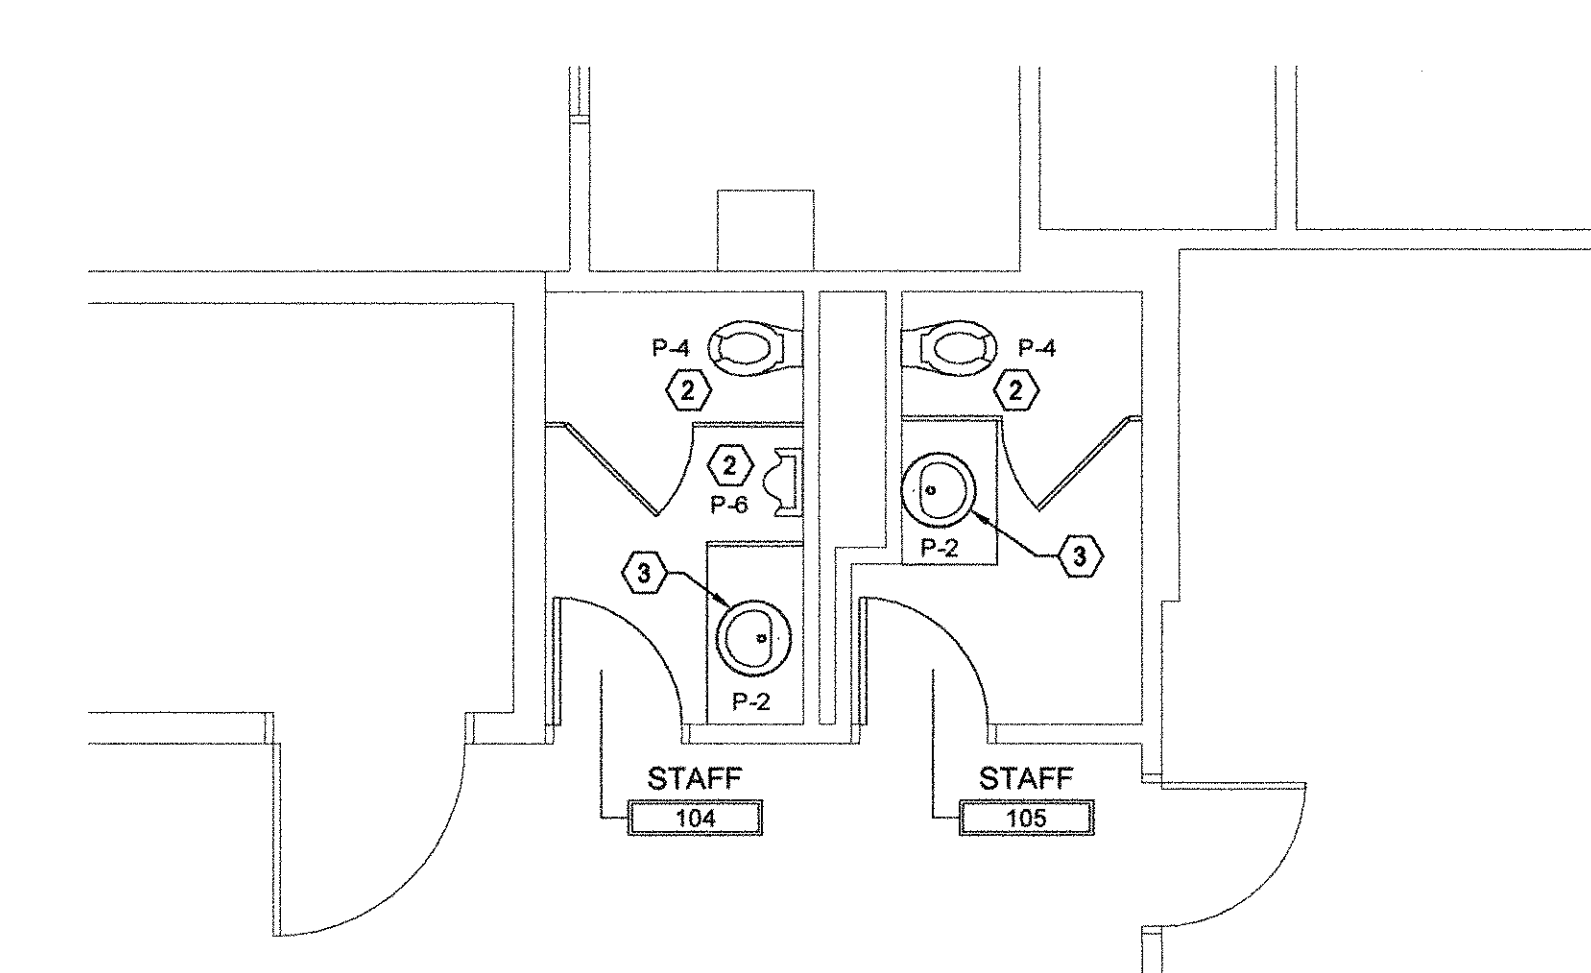

PLUMBING PLAN
STAFF TOILET
0 5 1 2 4 8 12 FT.
SCALE: 1/4"=1'-0"

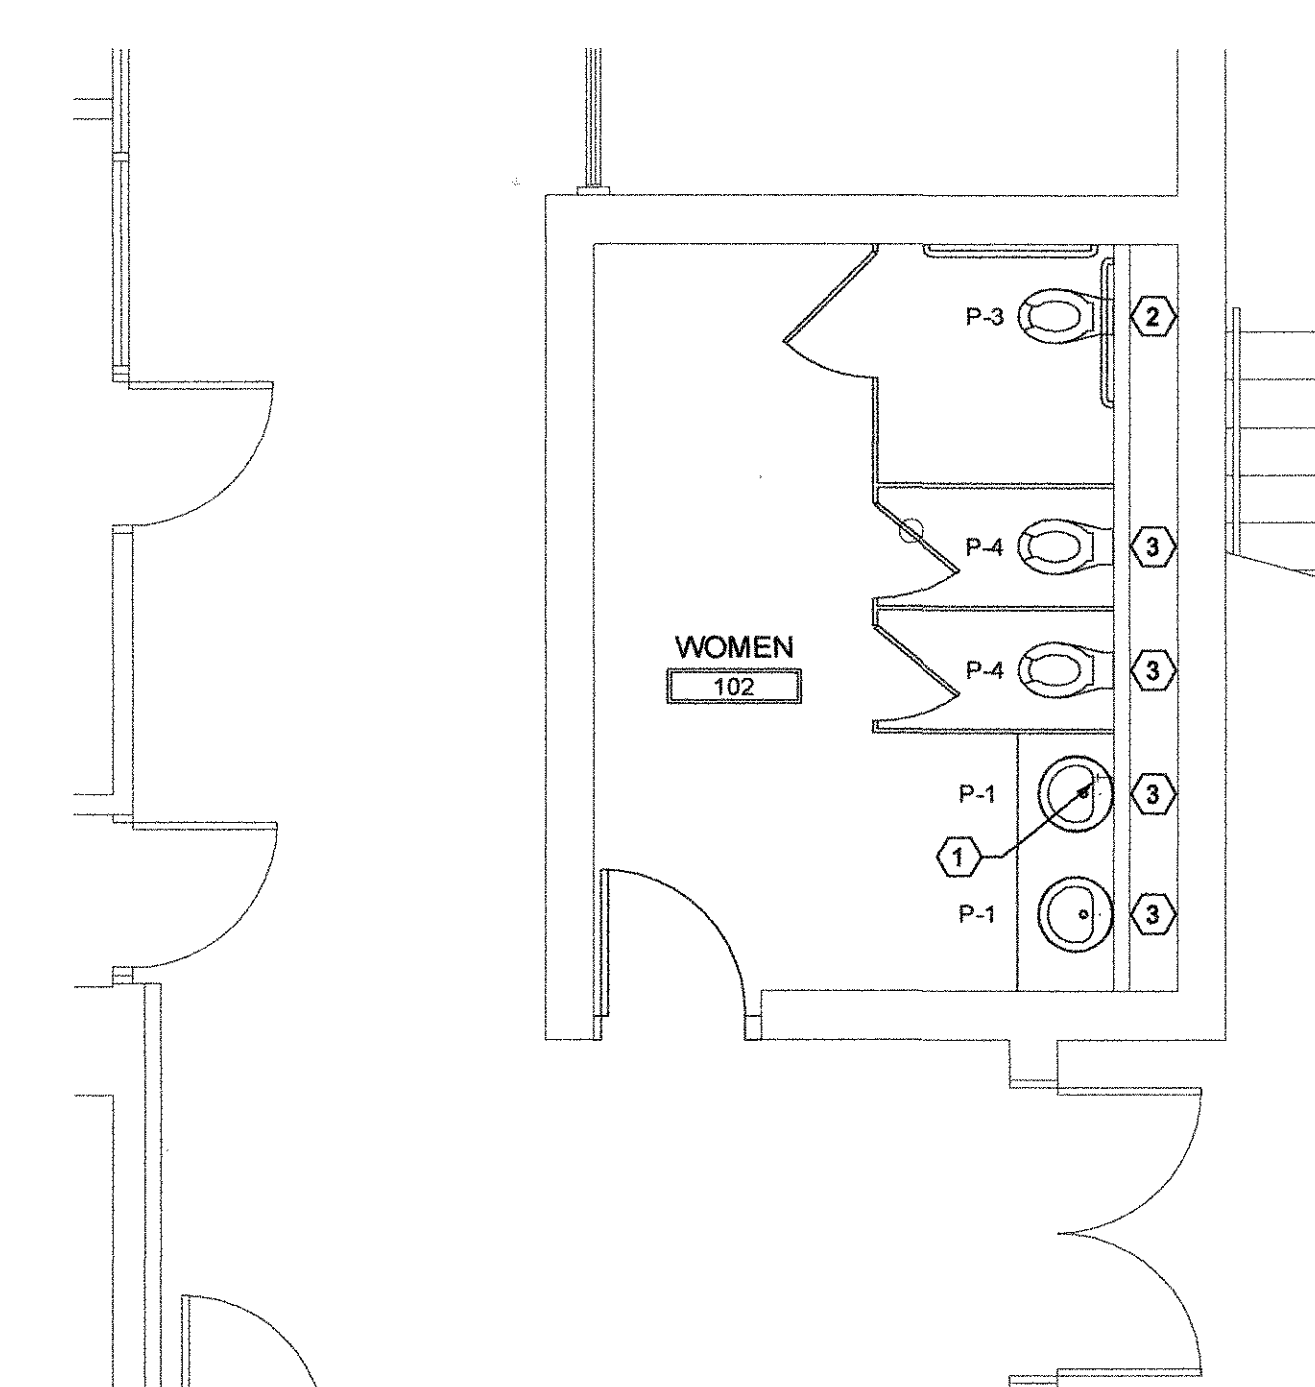

PLUMBING PLAN
WOMEN'S TOILET - SOUTH
0 5 1 2 4 8 12 FT.
SCALE: 1/4"=1'-0"

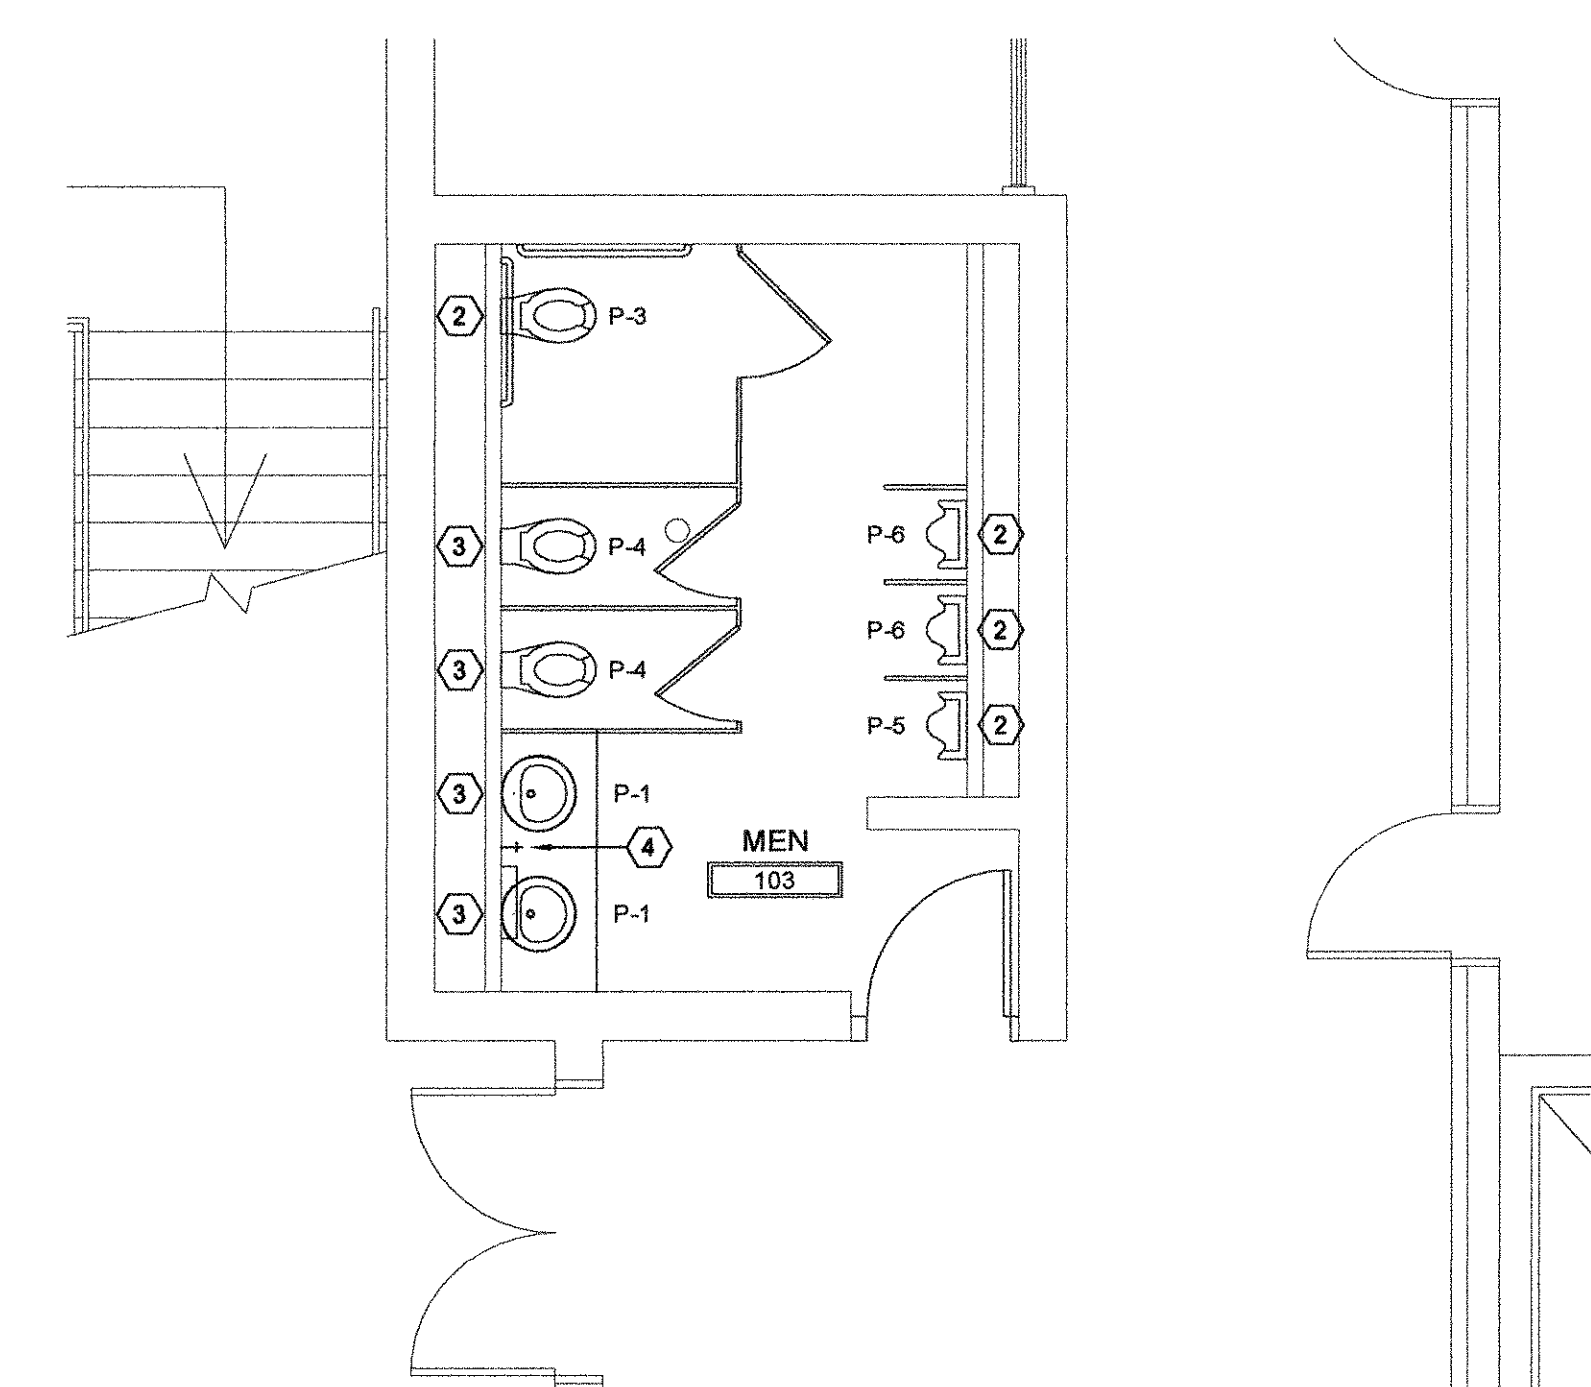


PLUMBING PLAN
MEN'S TOILET - SOUTH
0 5 1 2 4 8 12 FT.
SCALE: 1/4"=1'-0"

FIRST FLOOR PLUMBING NOTES:

- 1 - REPLACE EXISTING HOSE BIBB w/
NEW 1/2" HOSE BIBB (UNDER COUNTER)
SEE PLUMBING FIXTURE SCHEDULE
LOCATED ON DRAWING P200
- 2 - INSTALL NEW PLUMBING FIXTURE.
REUSE EXISTING WASTE, VENT AND
POTABLE WATER PIPING IF POSSIBLE.
(CONTRACTOR TO FIELD VERIFY
EXISTING CONDITIONS)
SEE PLUMBING FIXTURE SCHEDULE
LOCATED ON DRAWING P200
- 3 - INSTALL NEW PLUMBING FIXTURE.
TIE INTO EXISTING WASTE, VENT
AND POTABLE WATER PIPING.
(CONTRACTOR TO FIELD VERIFY
EXISTING CONDITIONS)
SEE PLUMBING FIXTURE SCHEDULE
LOCATED ON DRAWING P200
- 4 - INSTALL NEW 1/2" HOSE BIBB
(UNDER COUNTER)
TIE INTO EXISTING POTABLE
WATER PIPING.
(CONTRACTOR TO FIELD VERIFY
EXISTING CONDITIONS)
SEE PLUMBING FIXTURE SCHEDULE
LOCATED ON DRAWING P200


SCOPE OF WORK IN THIS CONTRACT SHALL INCLUDE FIRST FLOOR
RESTROOM RENOVATIONS IN BASE BID.
PROVIDE ADD ALTERNATE #1 FOR SECOND FLOOR RESTROOM
RENOVATIONS

REV	DATE	BY	DESCRIPTION
0	04/22/2013	CVW	ISSUED FOR BID
REVISIONS			
DRAWN BY:	WBR	DATE:	08/08/2012
CHECKED BY:	CVW	DATE:	08/10/2012

 Since 1980 Architects • Engineers • Landscape Architects •	USC AIKEN AIKEN, SOUTH CAROLINA PENLAND BUILDING RESTROOM RENOVATIONS FIRST FLOOR PLUMBING PLANS			
	JOHNSON, LASCHNER & ASSOCIATES, P.C. 1296 BROAD STREET TEL (706) 724-3756 AUGUSTA, GEORGIA 30901 FAX (706) 724-3955			
	SCALE	DATE	PROJECT NO.	DRAWING NO.
	1/4"=1'-0"	8/8/2012	6930.1202	P100
REV. 0				


SECOND FLOOR PLUMBING NOTES:

- 1 - REPLACE EXISTING HOSE BIBB w/
NEW 1/2" HOSE BIBB (UNDER COUNTER)
SEE PLUMBING FIXTURE SCHEDULE
LOCATED ON DRAWING P200
- 2 - INSTALL NEW PLUMBING FIXTURE.
REUSE EXISTING WASTE, VENT AND
POTABLE WATER PIPING IF POSSIBLE.
(CONTRACTOR TO FIELD VERIFY
EXISTING CONDITIONS)
SEE PLUMBING FIXTURE SCHEDULE
LOCATED ON DRAWING P200
- 3 - INSTALL NEW PLUMBING FIXTURE.
TIE INTO EXISTING WASTE, VENT
AND POTABLE WATER PIPING.
(CONTRACTOR TO FIELD VERIFY
EXISTING CONDITIONS)
SEE PLUMBING FIXTURE SCHEDULE
LOCATED ON DRAWING P200

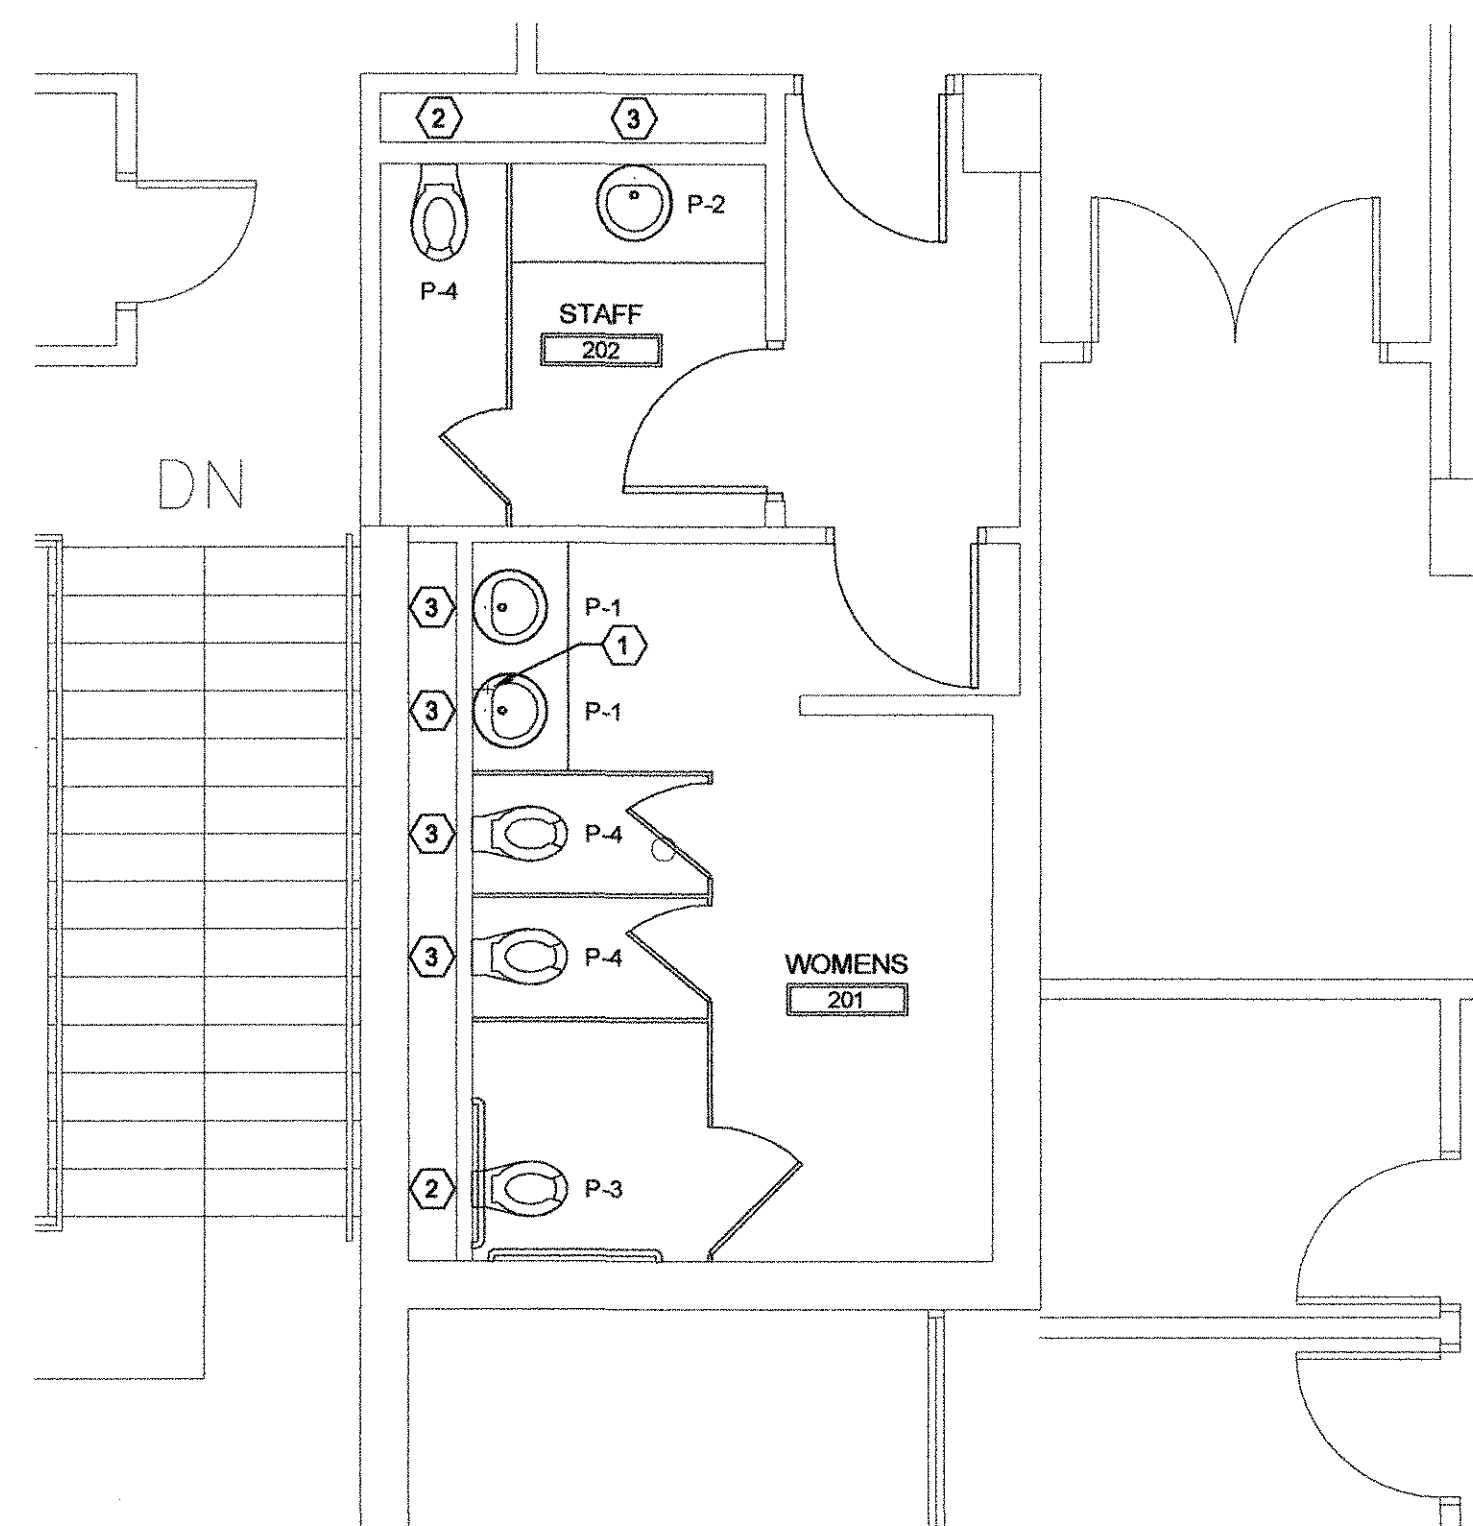


**PLUMBING PLAN
WOMEN'S TOILET - NORTH**

0 5 1 2 4 8 12 FT.
SCALE: 1/4"=1'-0"

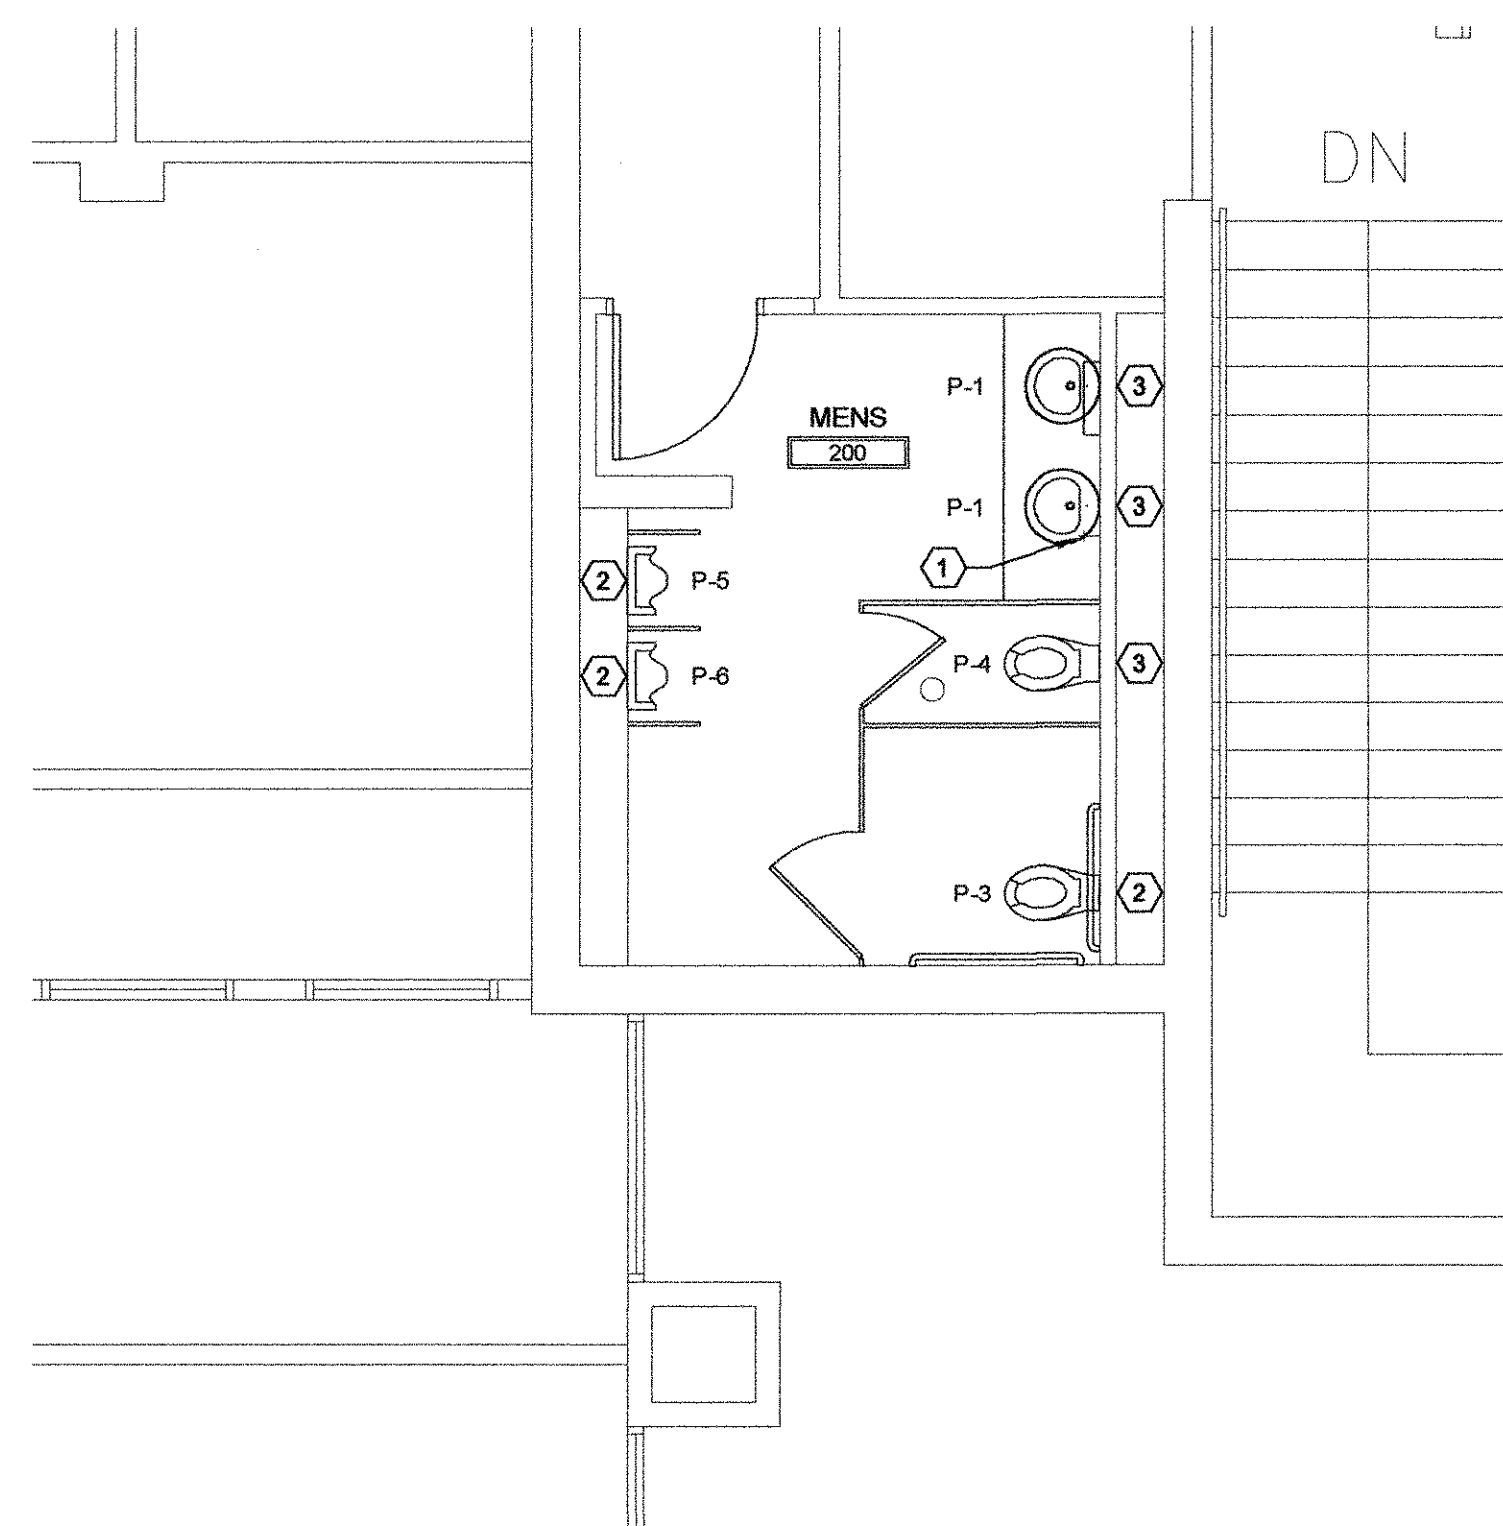


**PLUMBING PLAN
MEN'S TOILET - NORTH**

0 5 1 2 4 8 12 FT.
SCALE: 1/4"=1'-0"

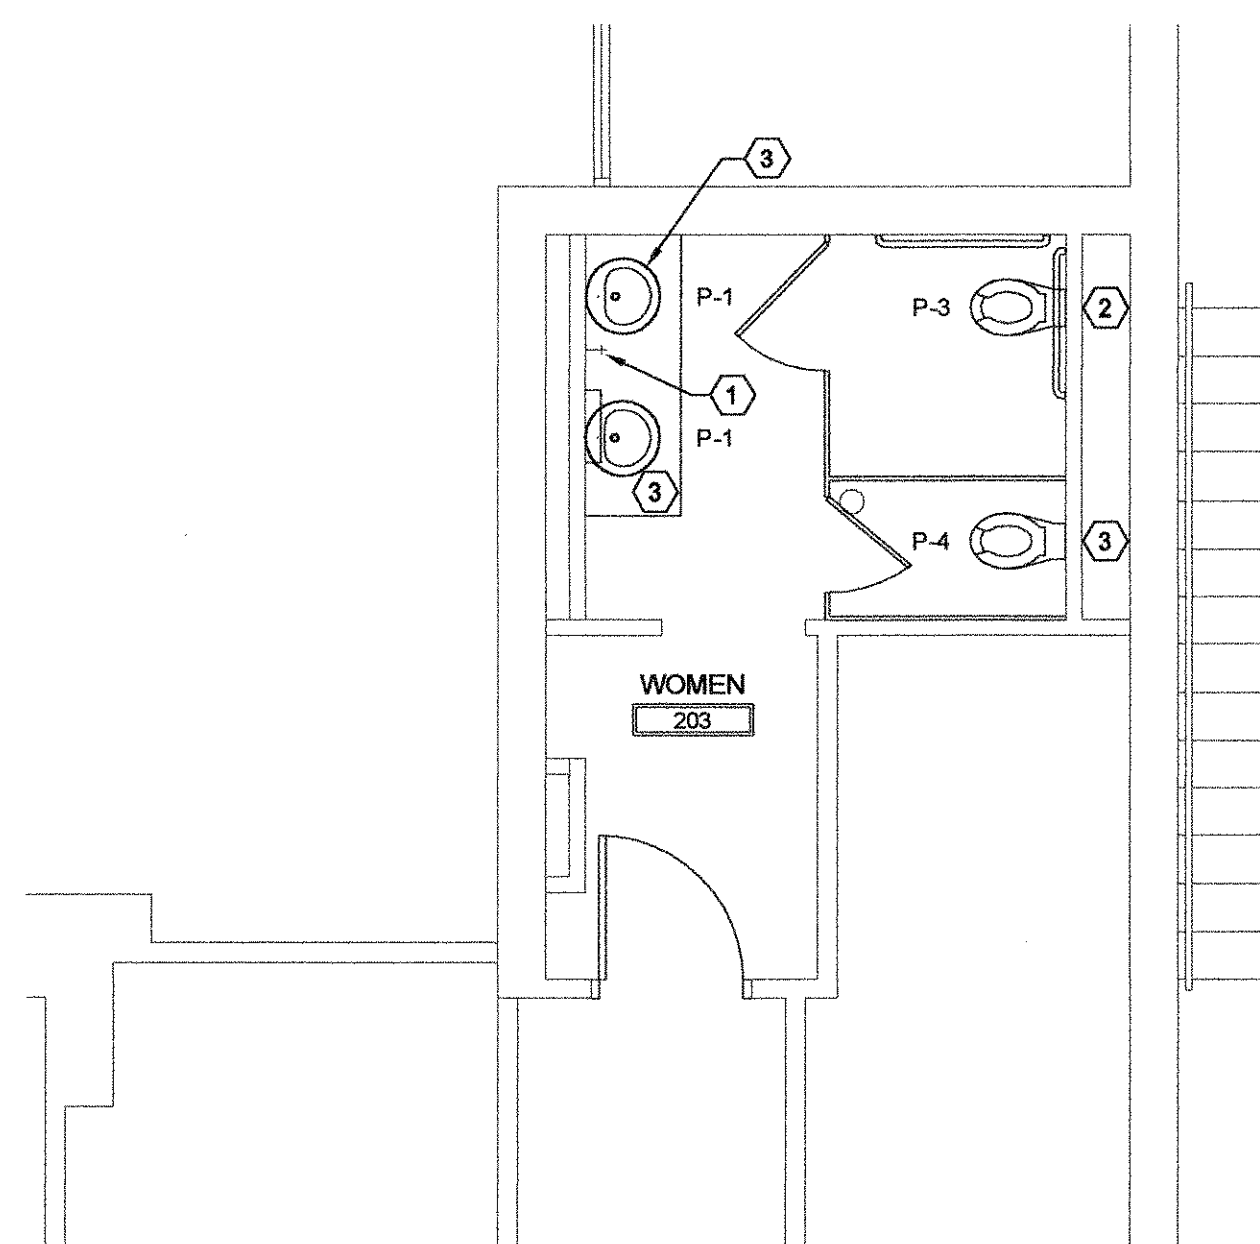

**PLUMBING PLAN
WOMEN'S TOILET - SOUTH**

0 5 1 2 4 8 12 FT.
SCALE: 1/4"=1'-0"

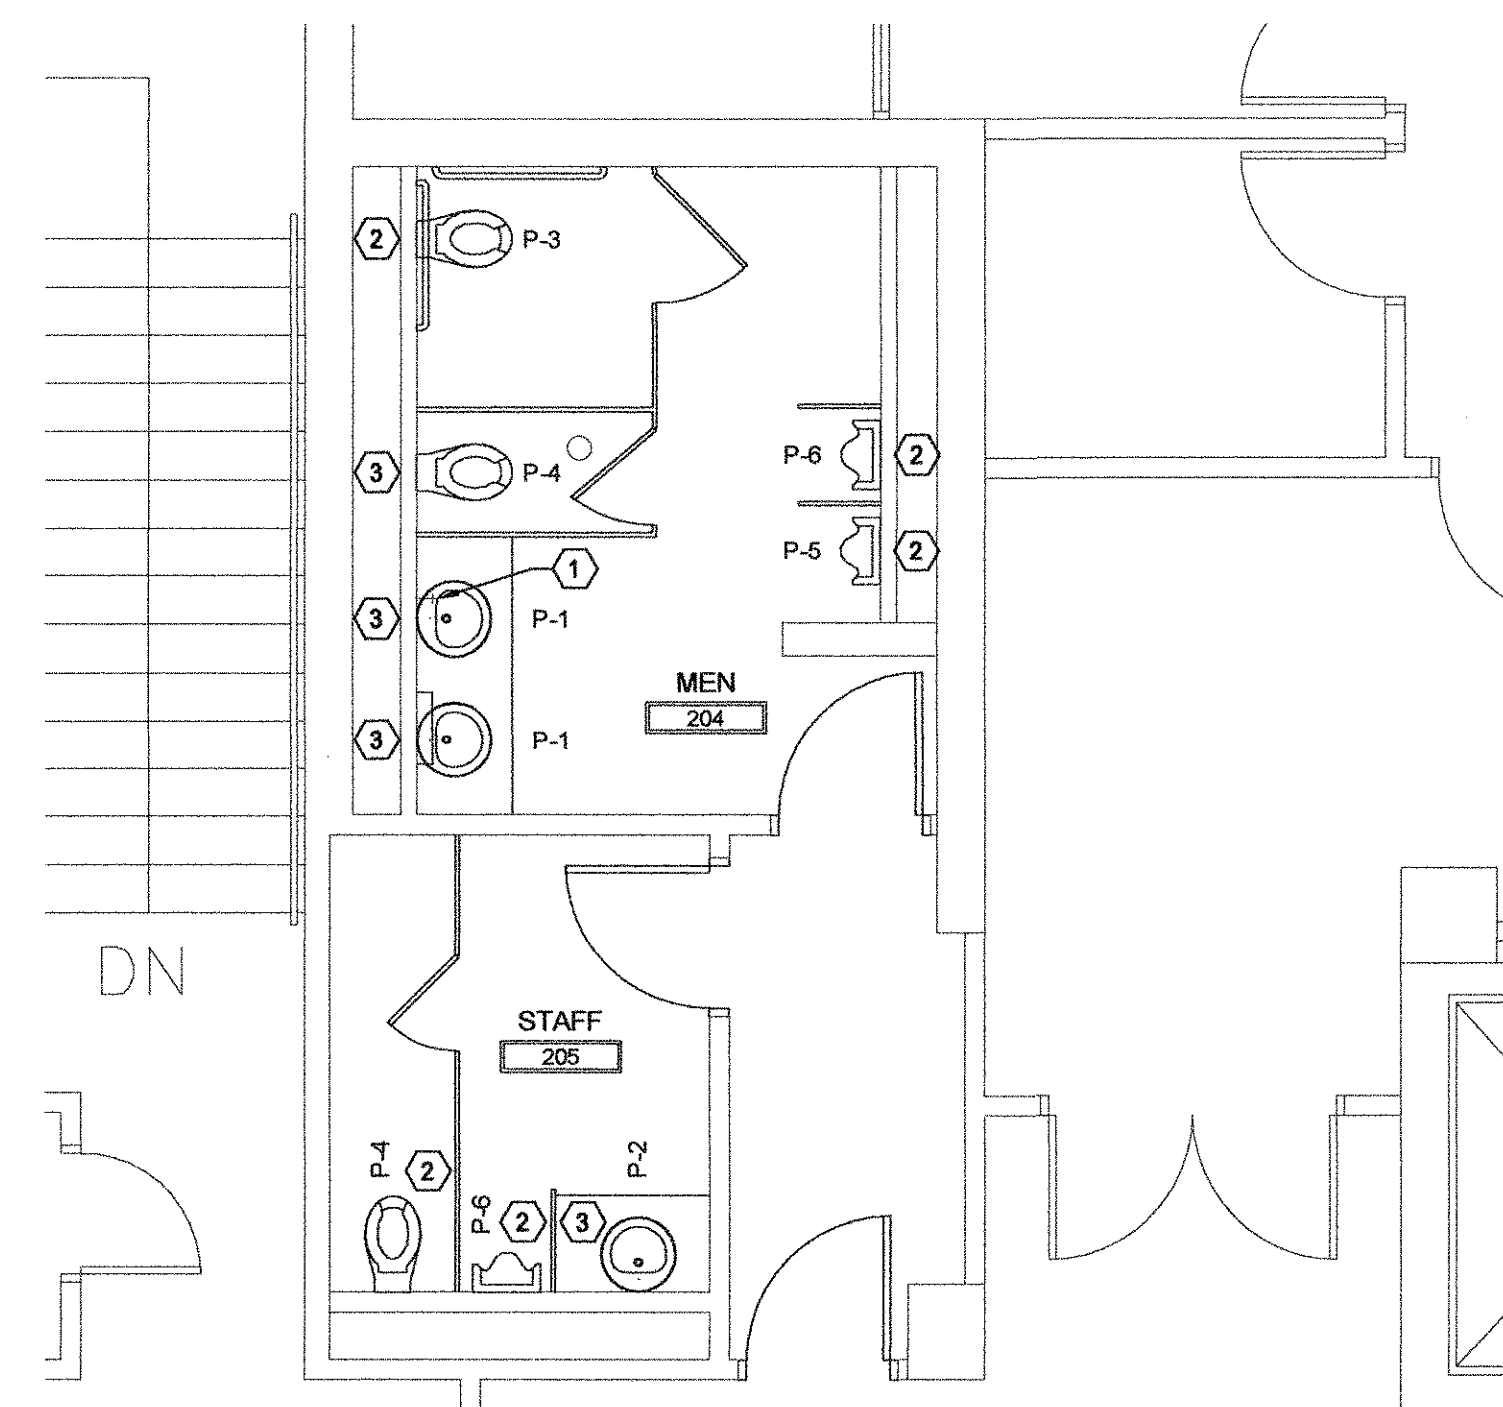


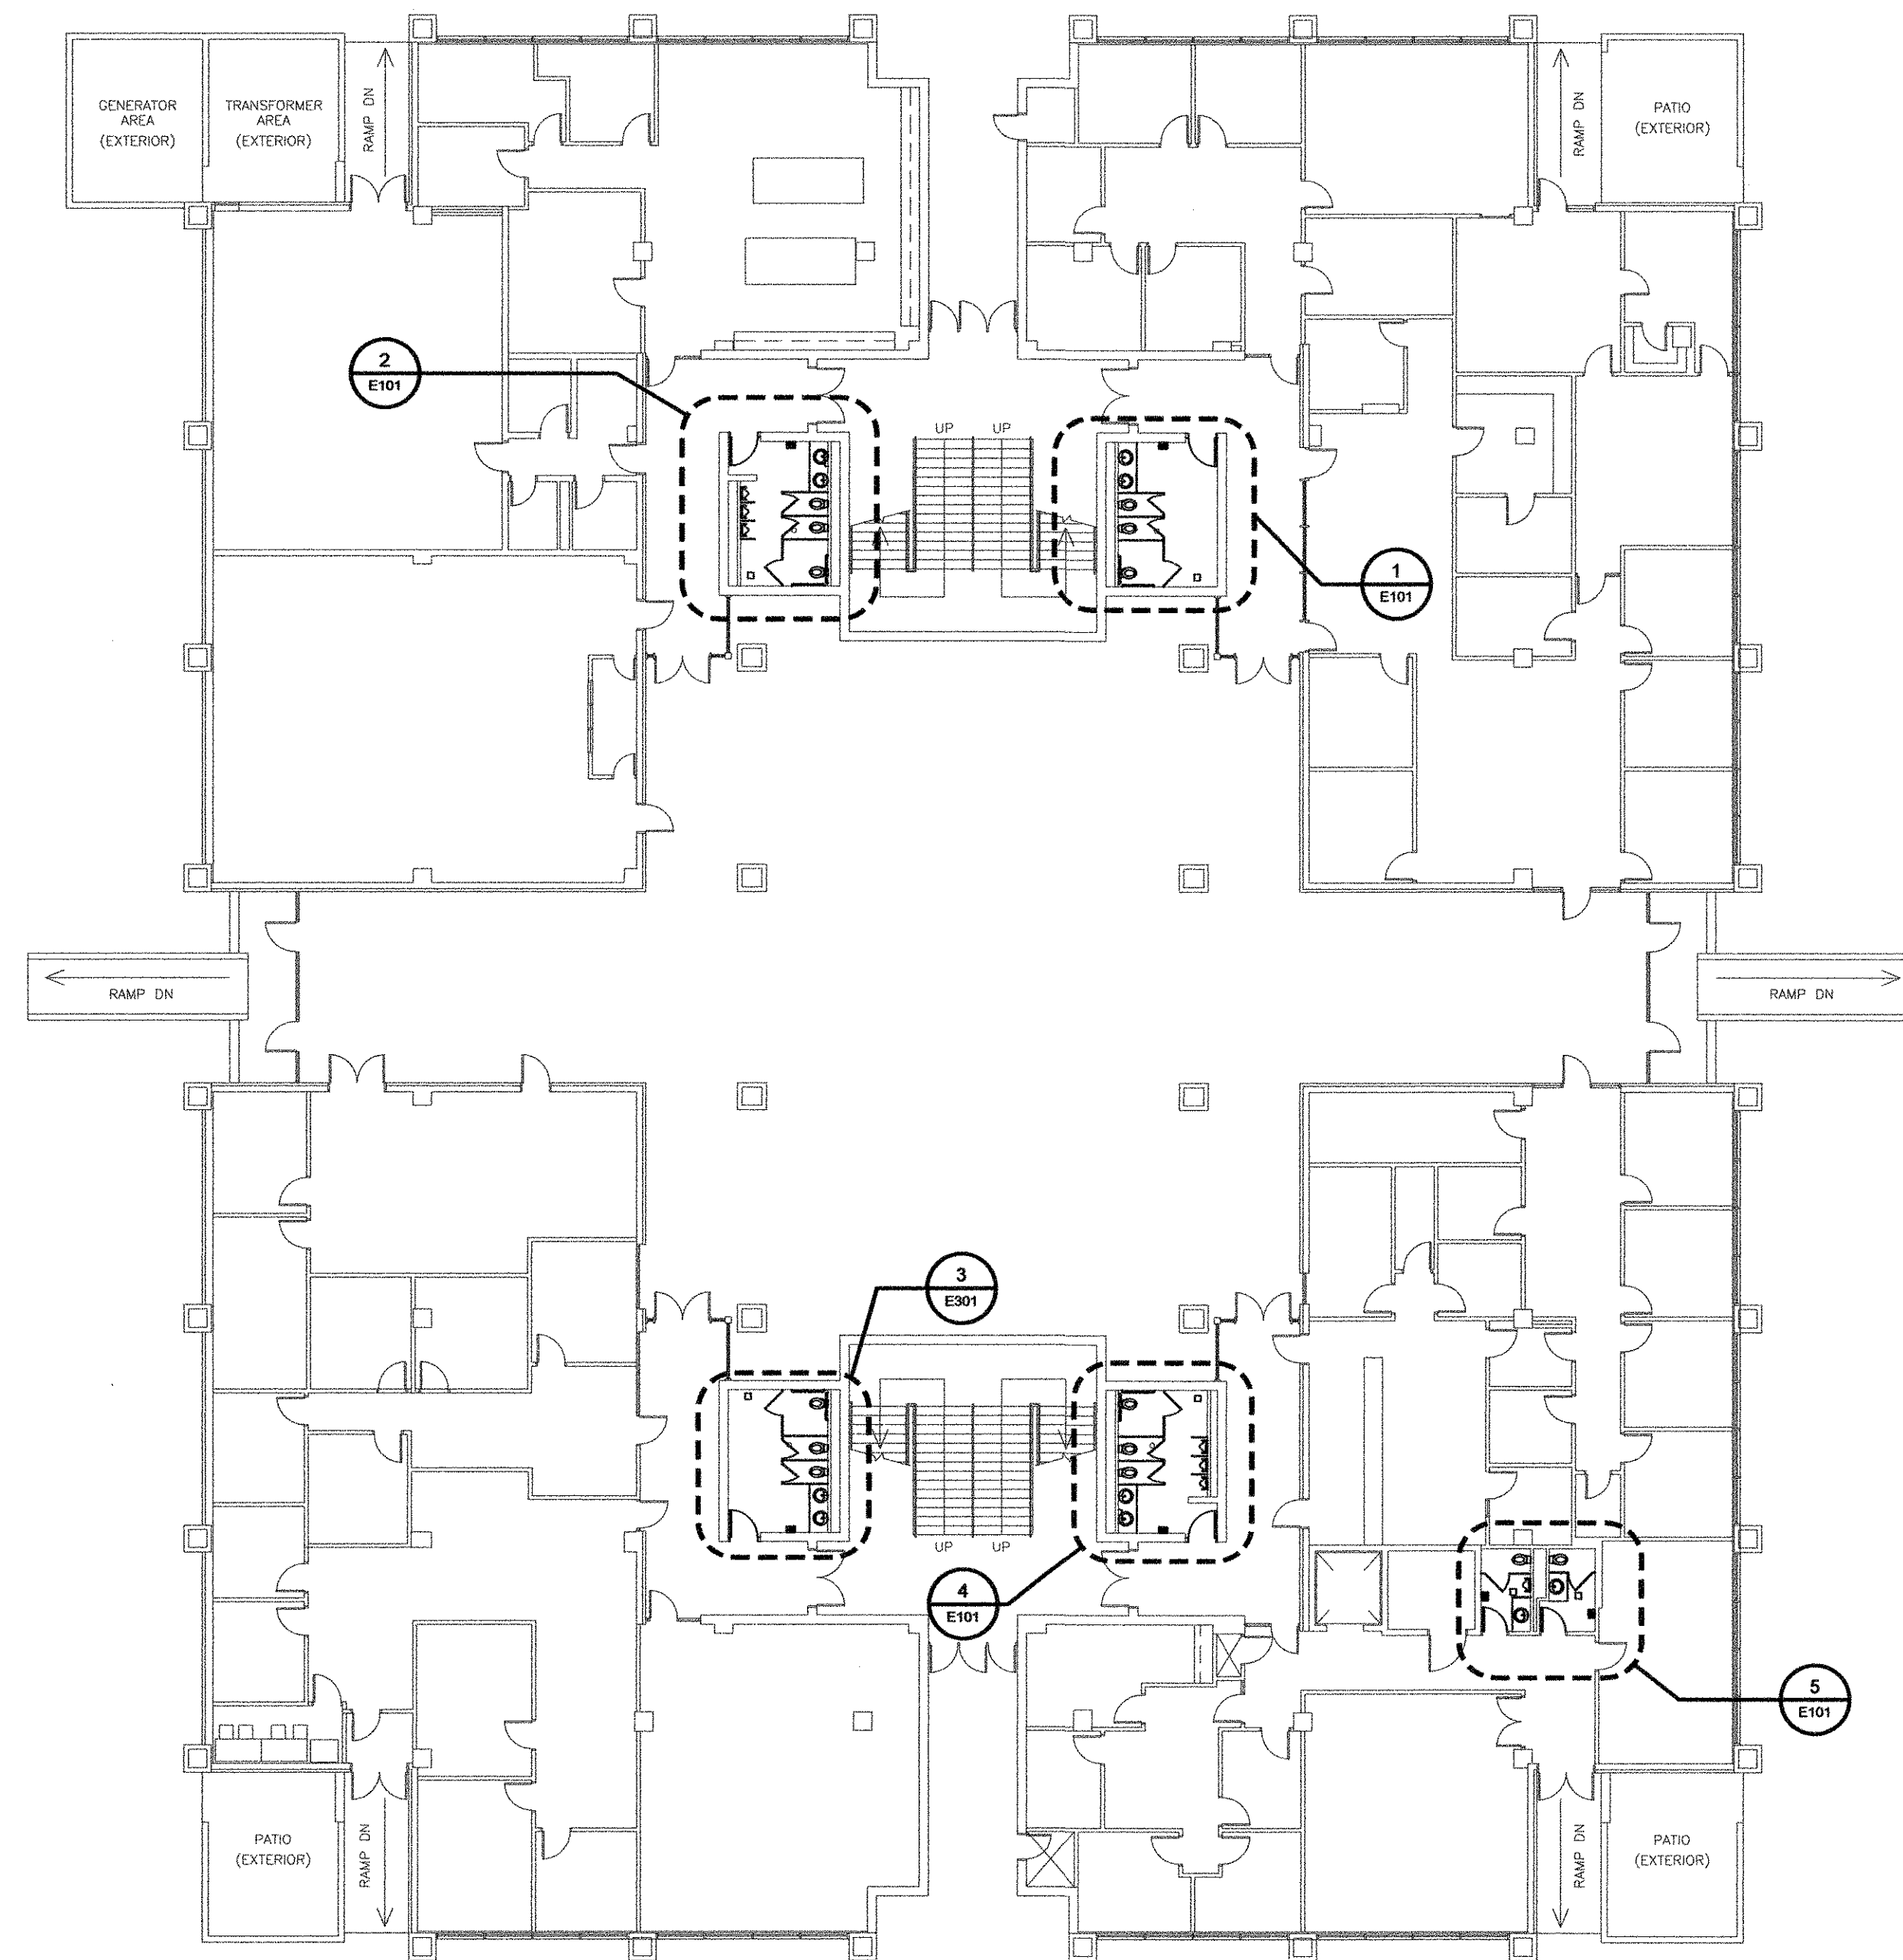
**PLUMBING PLAN
MEN'S TOILET - SOUTH**

0 5 1 2 4 8 12 FT.
SCALE: 1/4"=1'-0"


SCOPE OF WORK IN THIS CONTRACT SHALL INCLUDE FIRST FLOOR
RESTROOM RENOVATIONS IN BASE BID.
PROVIDE ADD ALTERNATE #1 FOR SECOND FLOOR RESTROOM
RENOVATIONS

REV	DATE	BY	DESCRIPTION
0	04/22/2013	CVW	ISSUED FOR BID
REVISIONS			
DRAWN BY:	WBR	DATE:	08/08/2012
CHECKED BY:	CVW	DATE:	08/10/2012


 Since 1980 Architects • Engineers • Landscape Architects •		USC AIKEN AIKEN, SOUTH CAROLINA	
		PENLAND BUILDING RESTROOM RENOVATIONS SECOND FLOOR PLUMBING PLANS	
JOHNSON, LASCHNER & ASSOCIATES, P.C. 1296 BROAD STREET TEL (706) 724-5756		AUGUSTA, GEORGIA 30901 FAX (706) 724-3955	
SCALE 1/4"=1'-0"	DATE 8/8/2012	PROJECT NO. 6930.1202	DRAWING NO. P101
		REV. 0	



OVERALL ELECTRICAL PLAN
FIRST FLOOR


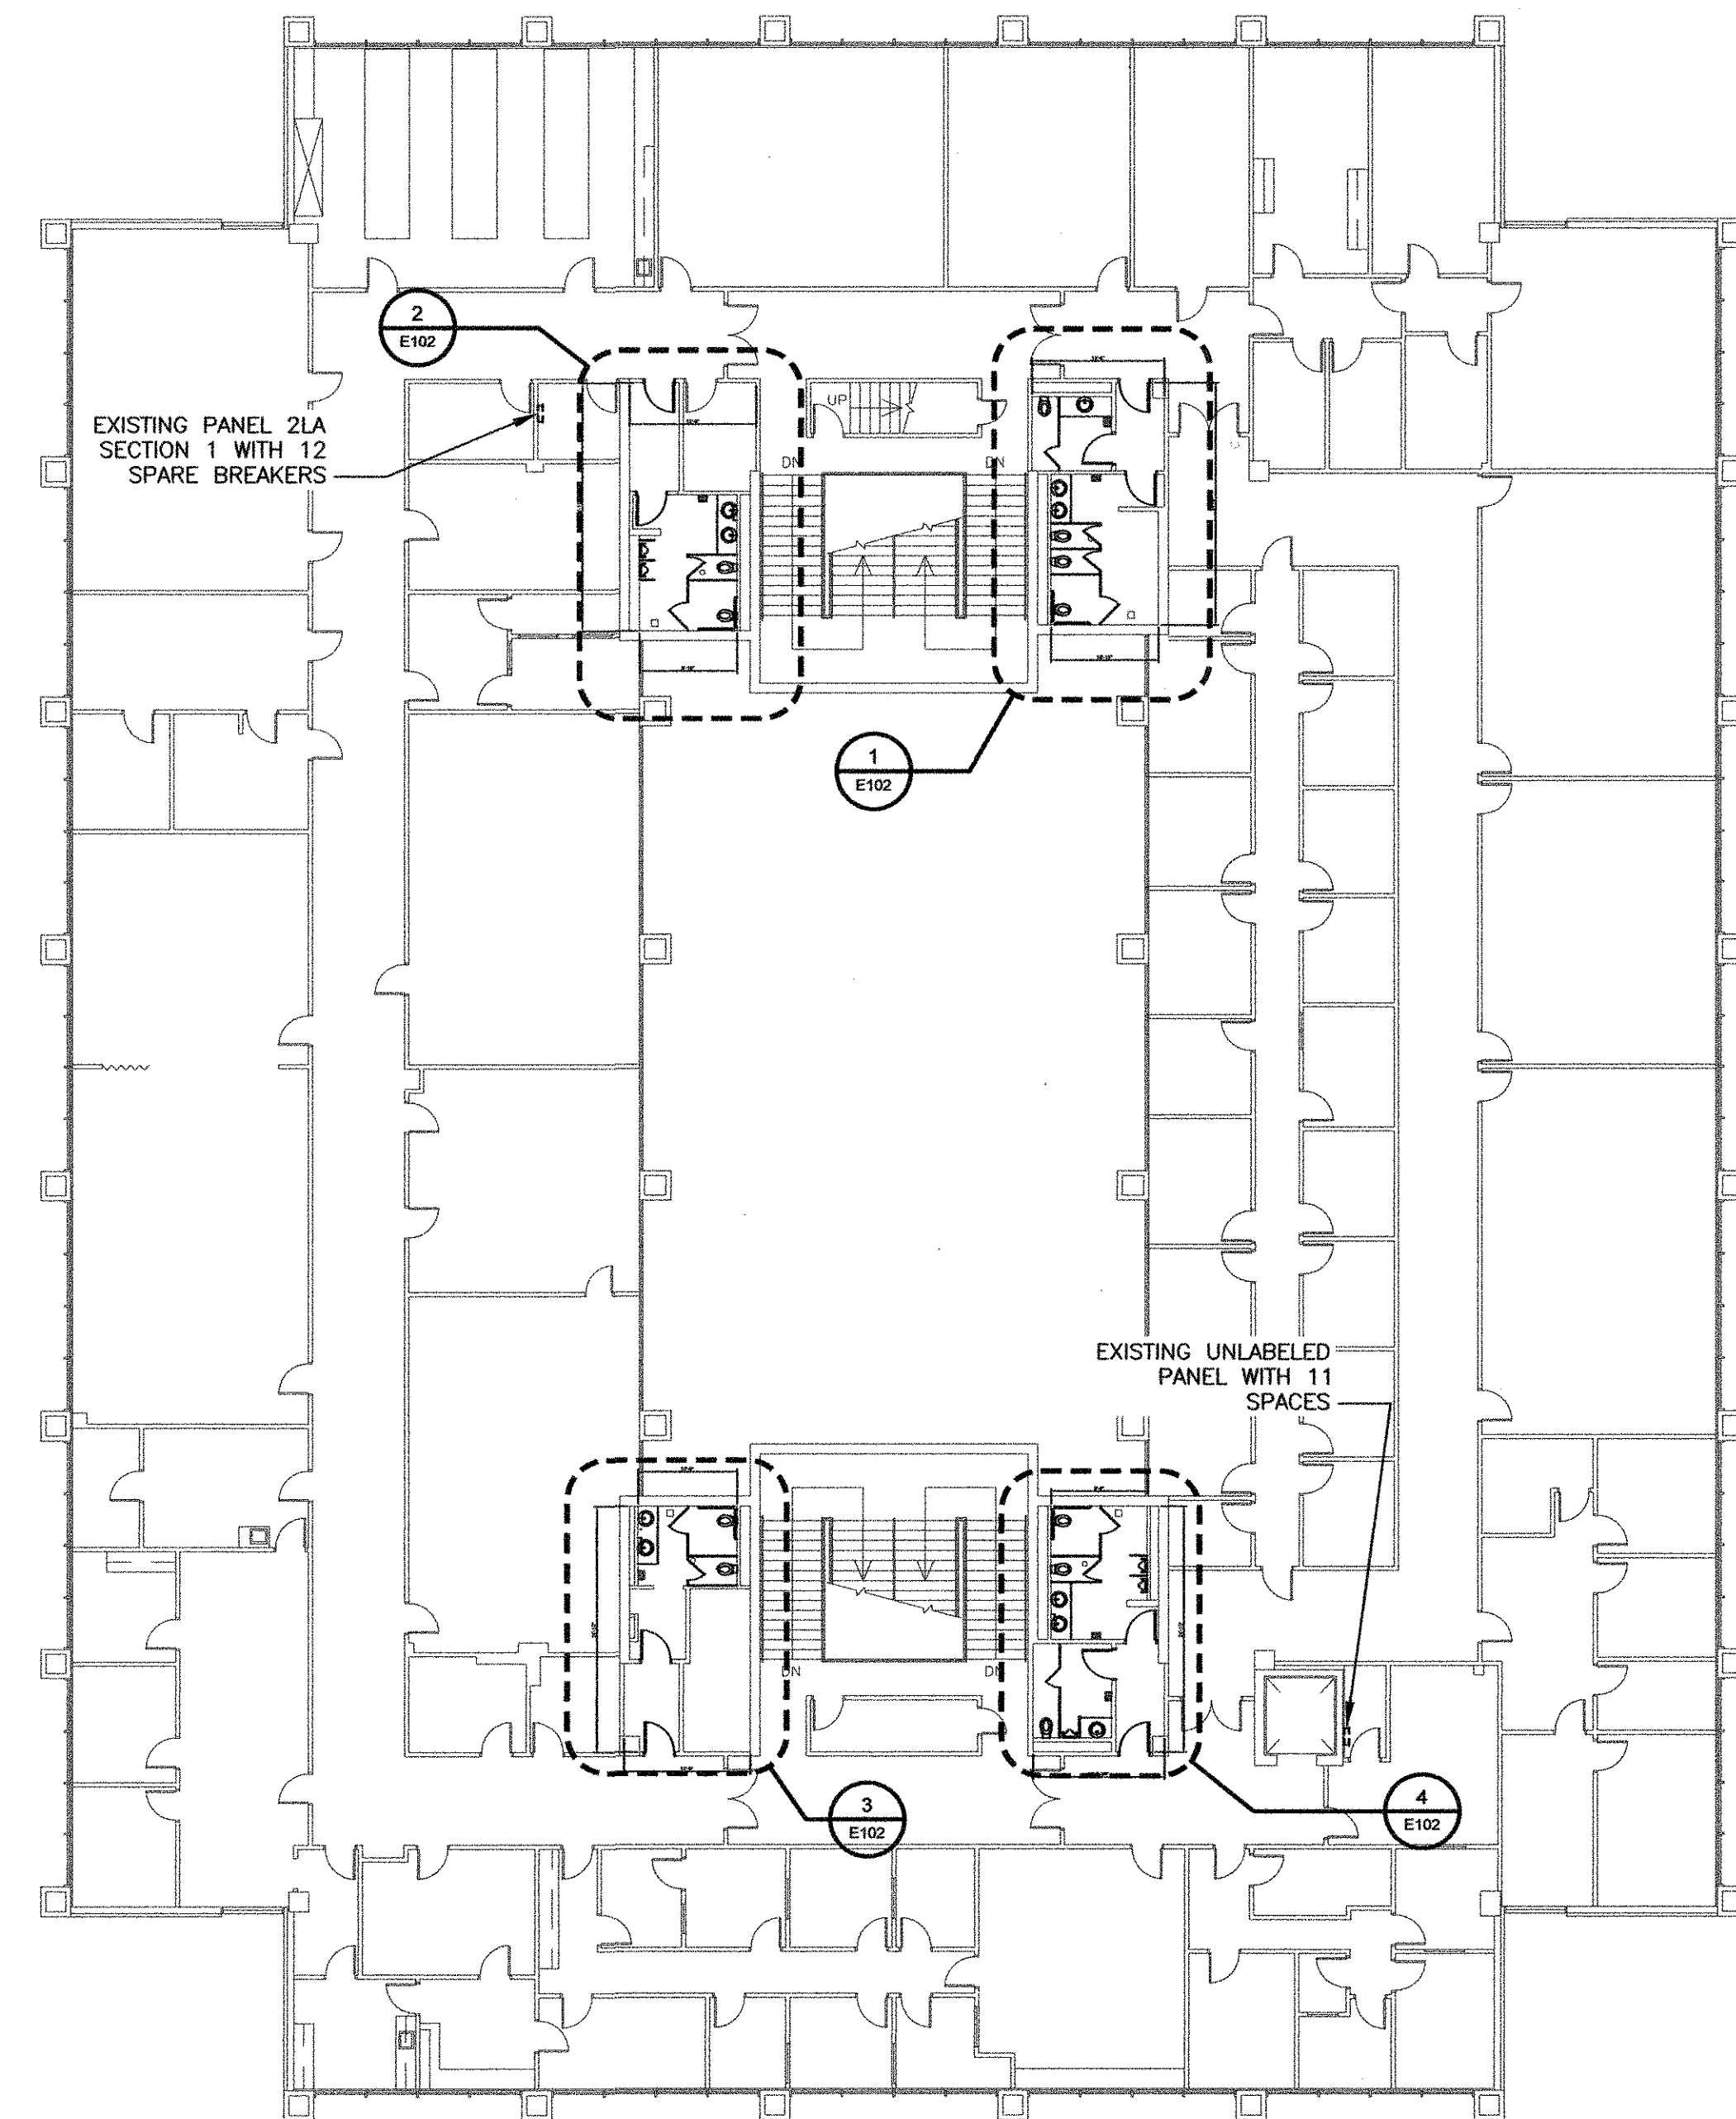


OVERALL ELECTRICAL PLAN
SECOND FLOOR

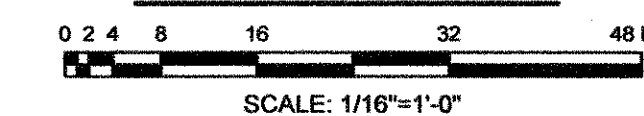

REV	DATE	BY	DESCRIPTION
0	4/22/2013	RBS	ISSUED FOR BID
REVISIONS			
DRAWN BY: MWH DATE: 08/08/2012 CHECKED BY: RBS DATE: 08/10/2012			

SCOPE OF WORK IN THIS CONTRACT SHALL INCLUDE FIRST FLOOR RESTROOM RENOVATIONS IN BASE BID. PROVIDE ADD ALTERNATE #1 FOR SECOND FLOOR RESTROOM RENOVATIONS

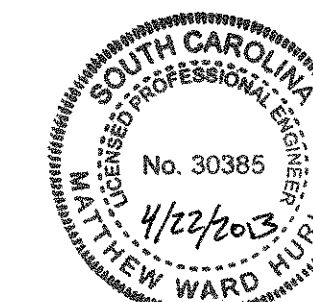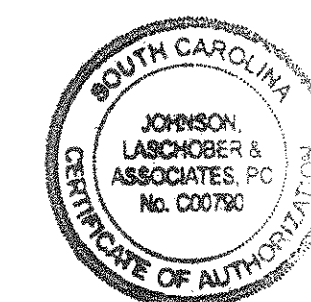

USC AIKEN AIKEN, SOUTH CAROLINA			
PENLAND BUILDING RESTROOM RENOVATIONS ELECTRICAL OVERALL PLAN			
JOHNSON, LASCHOB & ASSOCIATES, P.C. 1296 BROAD STREET AUGUSTA, GEORGIA 30901 TEL (706) 724-5756 FAX (706) 724-3955			
SCALE 1/4"=1'-0"	DATE 8/8/2012	PROJECT NO. 6930.1202	DRAWING NO. E100 REV. 0

GENERAL NOTES

1. ALL WORK SHALL CONFORM TO THE 2011 EDITION OF THE N.E.C.
2. COORDINATE OUTLET LOCATIONS WITH ARCHITECTURAL PLANS, ELEVATIONS AND DETAILS.
3. COORDINATE HVAC AND PLUMBING EQUIPMENT LOCATIONS WITH MECHANICAL PLANS, ELEVATIONS AND DETAILS.
4. CONSULT MANUFACTURERS' SHOP DRAWINGS FOR REQUIREMENTS AND EXACT LOCATION OF ELECTRICAL CONNECTIONS FOR EQUIPMENT FURNISHED BY OTHERS. BRANCH CIRCUIT WIRING SHALL MEET ALL REQUIREMENTS OF THE EQUIPMENT MANUFACTURER.
5. MOUNTING HEIGHT DIMENSIONS FOR WIRING DEVICES ARE FROM THE FINISHED FLOOR UP TO THE CENTER OF THE OUTLET BOX.
6. CENTER OUTLETS HORIZONTALLY IN ARCHITECTURAL FEATURES.
7. DO NOT SCALE DRAWINGS. DEVICE LOCATIONS ARE APPROXIMATE UNLESS DIMENSIONED. ACTUAL DEVICE LOCATIONS SHALL BE FIELD COORDINATED WITH ALL OTHER TRADES AND APPLICABLE CODES.

DRAWING NOTES

1. REINSTALL ALL FIRE ALARM DEVICES AFTER INSTALLATION OF CEILING. VERIFY PROPER OPERATION AND COMMUNICATIONS WITH FIRE ALARM CONTROL UNIT.
2. INSTALL NEW WIRING DEVICES AND WIRING DEVICE FACE PLATES FOR ALL SWITCHES AND RECEPTACLE OUTLETS IN MODIFIED ROOMS.

DEMOLITION NOTES

1. DEMOLISH AND REMOVE EXISTING LIGHT FIXTURES IN RESTROOMS THAT ARE TO BE RENOVATED
2. MAINTAIN CIRCUIT CONTINUITY FOR ALL REMAINING CIRCUITS

SYMBOLS

WALL FIXTURE OUTLET

FIXTURE TO BE FEISS VS17103CH WITH LED LAMPS
FIXTURE TO BE CONNECTED TO EXISTING LIGHTING CONDUCTORS AND CONTROLLED BY NEW OCCUPANCY SENSOR.
COORDINATE FIXTURE LOCATION WITH ARCHITECT

WALL FIXTURE OUTLET

FIXTURE TO BE MINKA LAVERY CASHELMARA 3243-77 WITH LED LAMPS
FIXTURE TO BE CONNECTED TO EXISTING LIGHTING CONDUCTORS AND CONTROLLED BY NEW OCCUPANCY SENSOR.
COORDINATE FIXTURE LOCATION WITH ARCHITECT

2' X 2' RECESSED FLUORESCENT TROFFER WITH 2 F17T8 LAMPS.

FIXTURE TO BE LIGHTOLIER ALS2QUP217UWVH
FIXTURE TO BE CONNECTED TO EXISTING LIGHTING CONDUCTORS AND CONTROLLED BY NEW OCCUPANCY SENSOR.

CEILING MOUNTED OCCUPANCY SENSOR.


TO BE WATTSTOPPER DW-355 OR EQUAL.

120V 9.8A HAND DRYER.


TO BE CONNECTED TO NEAREST PANEL WITH 2 #12 AND #12G
PROVIDE AND INSTALL 20A SINGLE POLE GFCI BREAKER FOR PANEL.

120V CONNECTION FOR AUTOMATIC FLUSH OR SINK FAUCETS SENSOR TRANSFORMERS.


POWER TO BE PROVIDED FROM NEAREST RECEPTACLE CIRCUIT.
COORDINATE ALL LOCATIONS WITH PLUMBING EQUIPMENT.

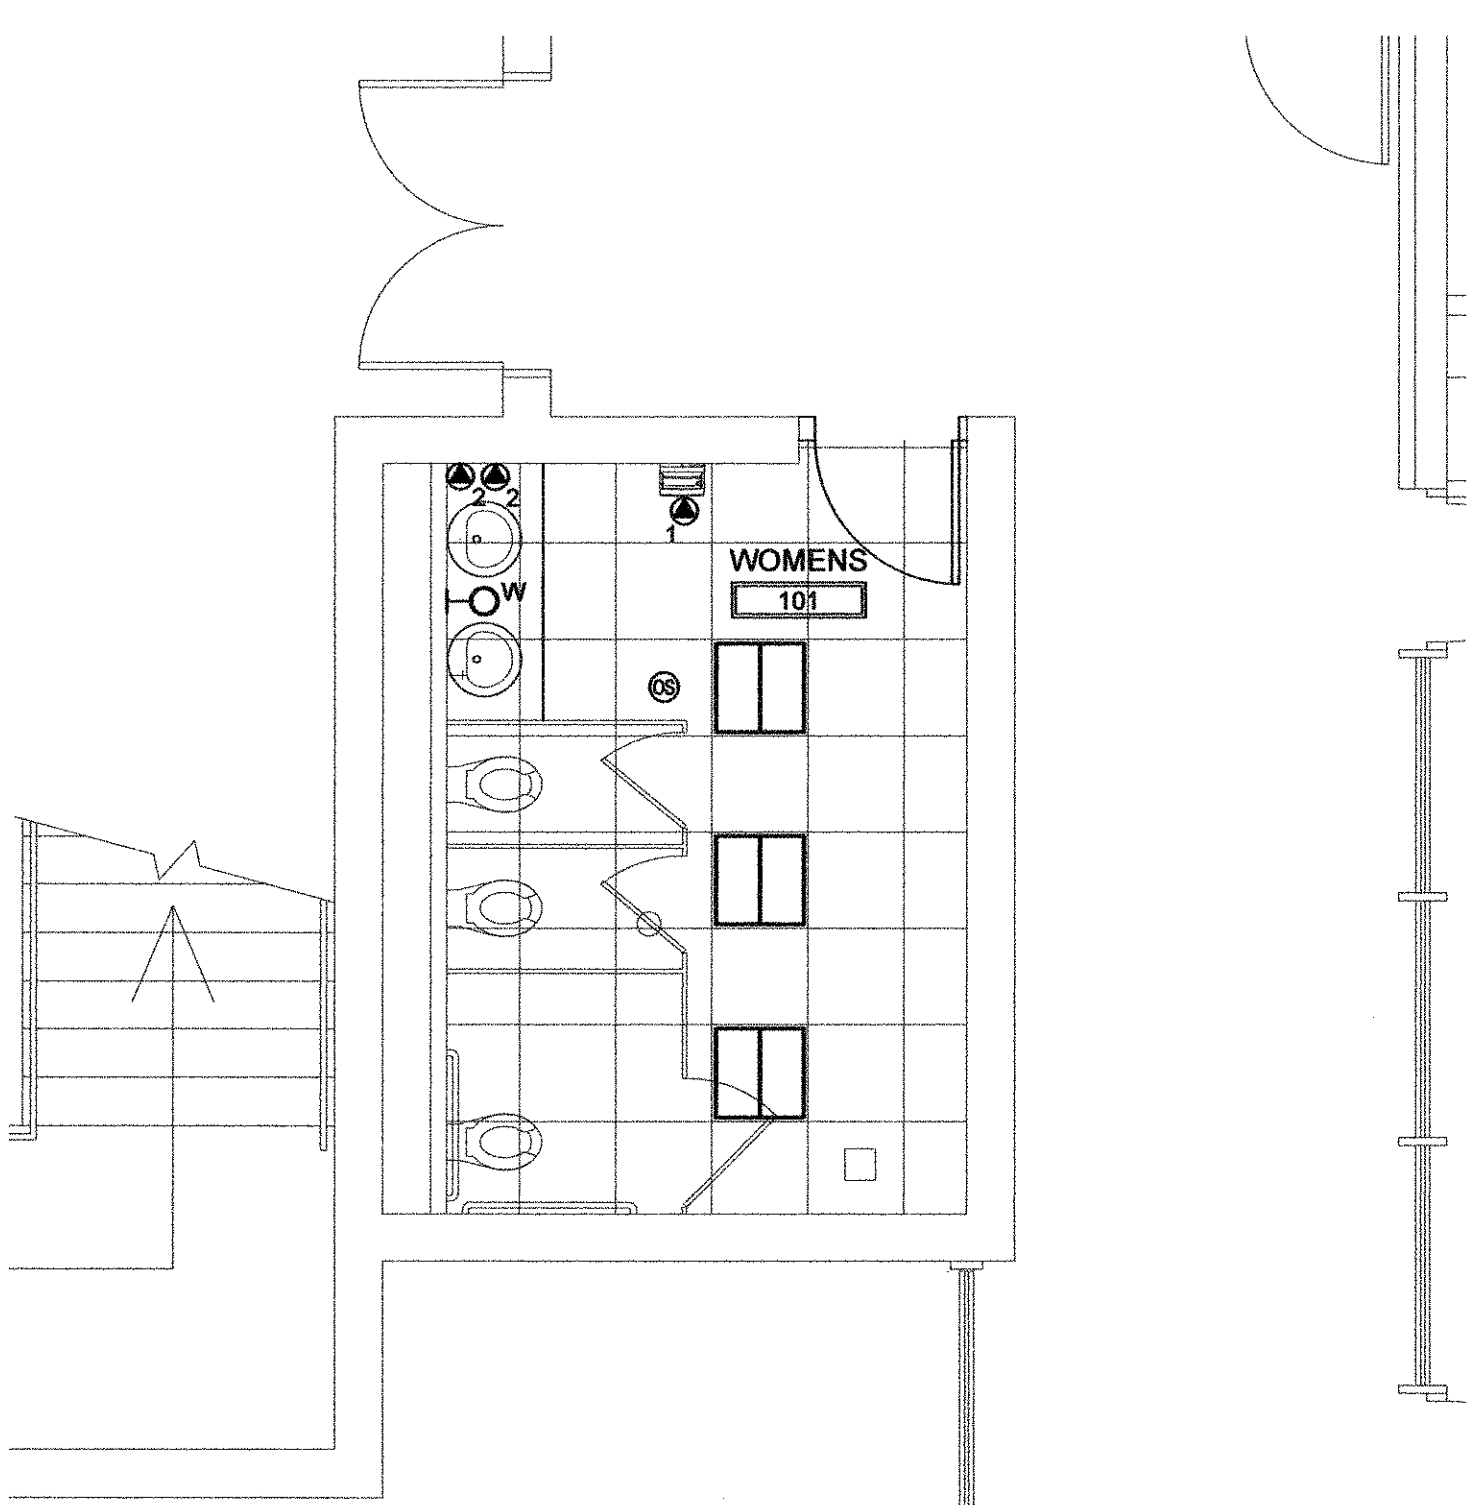


1 WOMEN'S TOILET - NORTH
E101 SCALE: 1/4" = 1'-0"

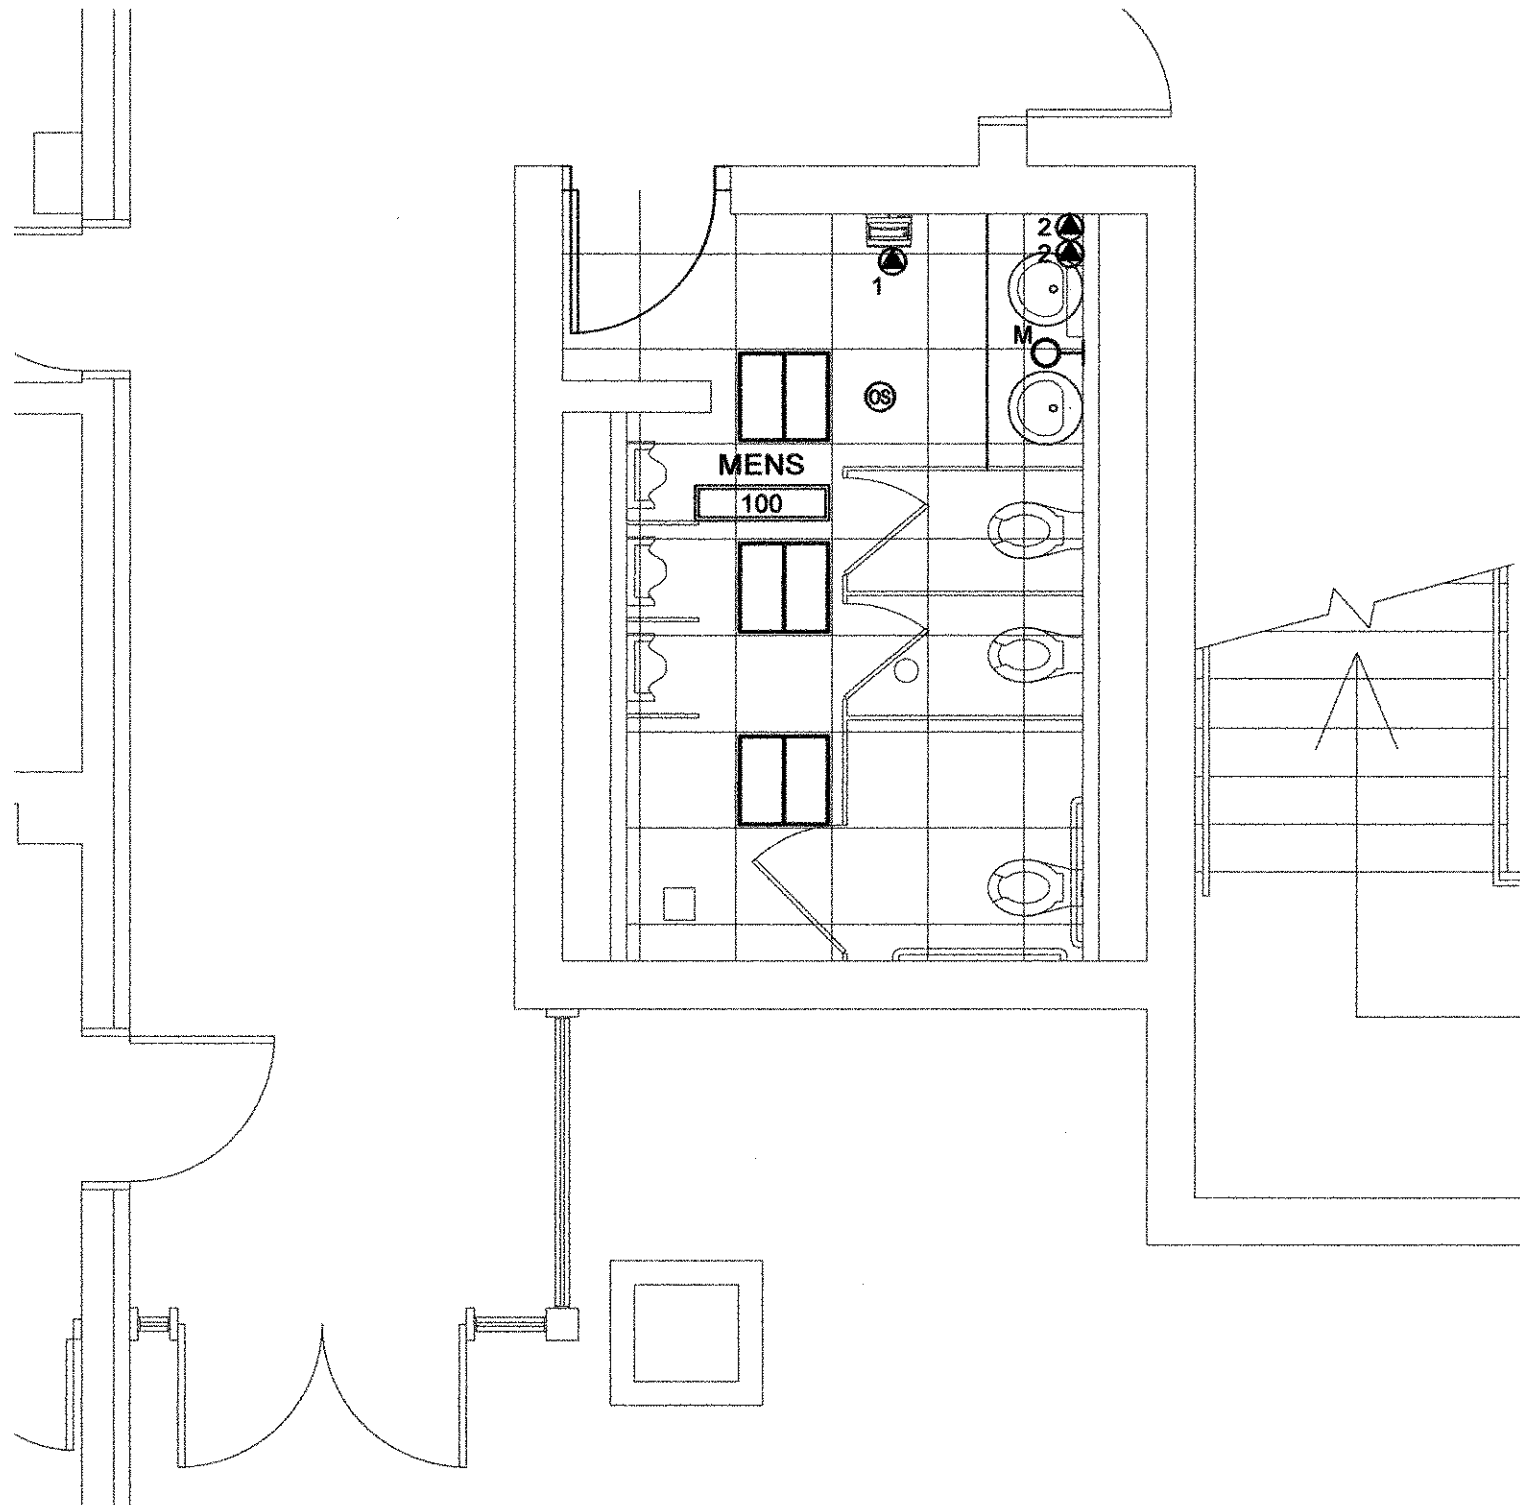


2 MEN'S TOILET - NORTH
E101 SCALE: 1/4" = 1'-0"

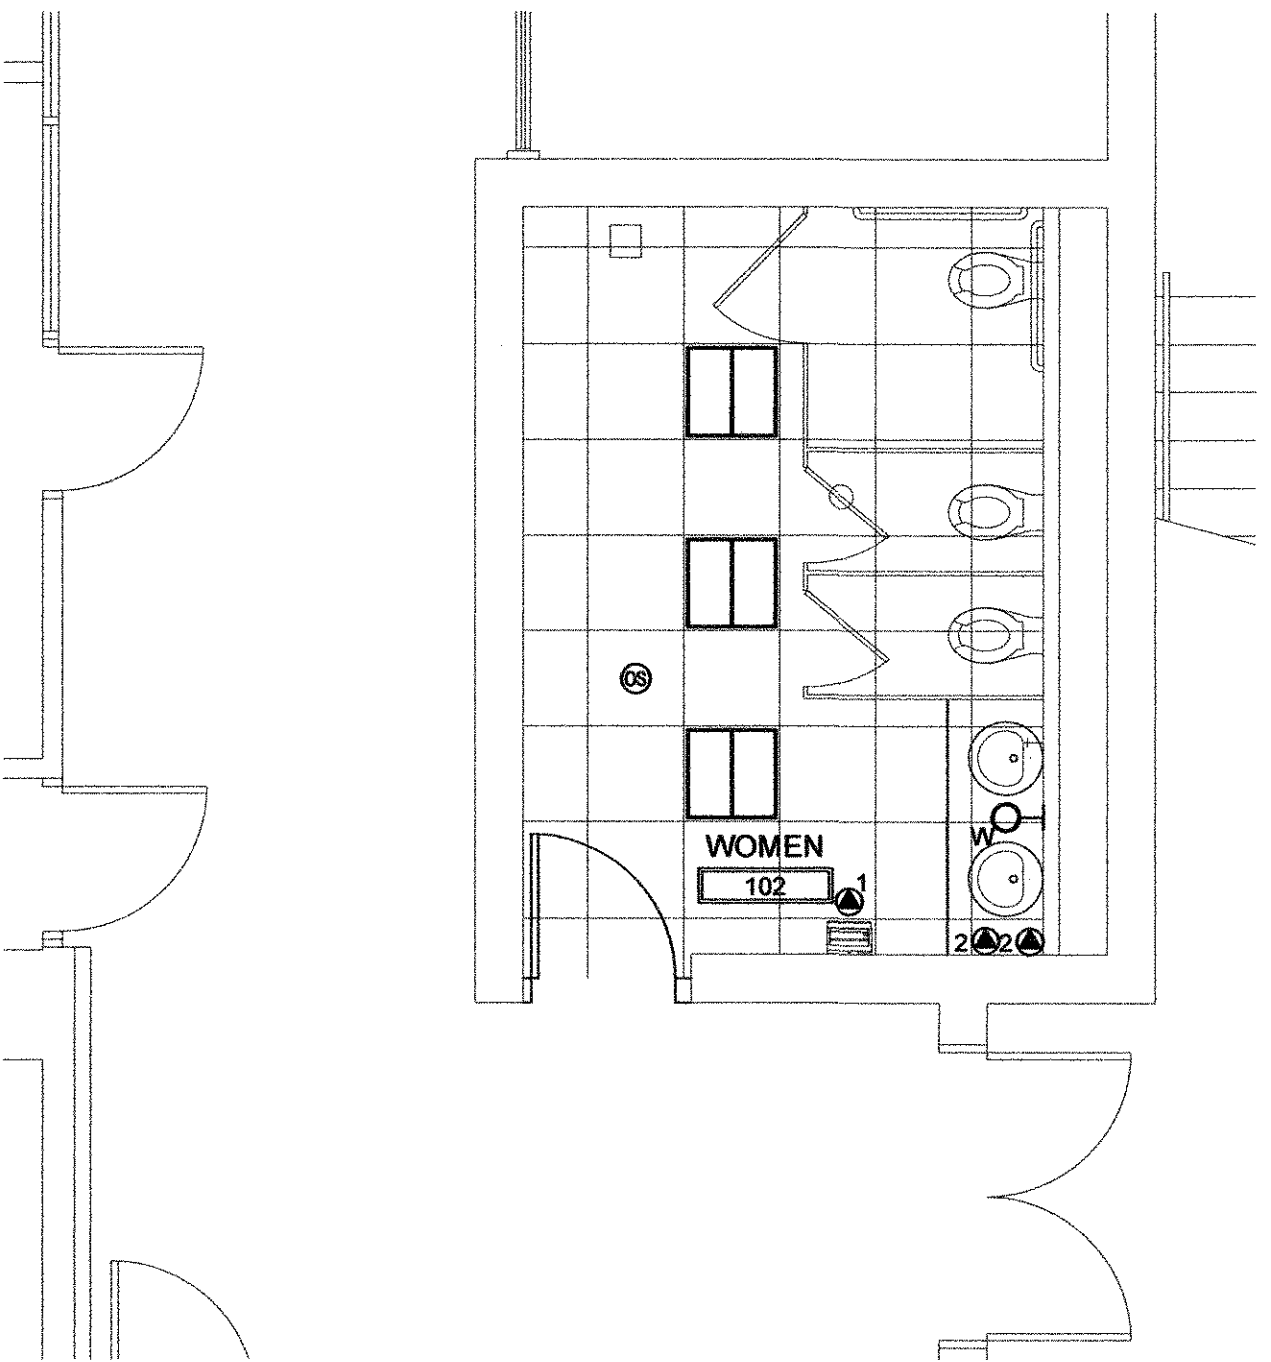

3 WOMEN'S TOILET - SOUTH
E101 SCALE: 1/4" = 1'-0"

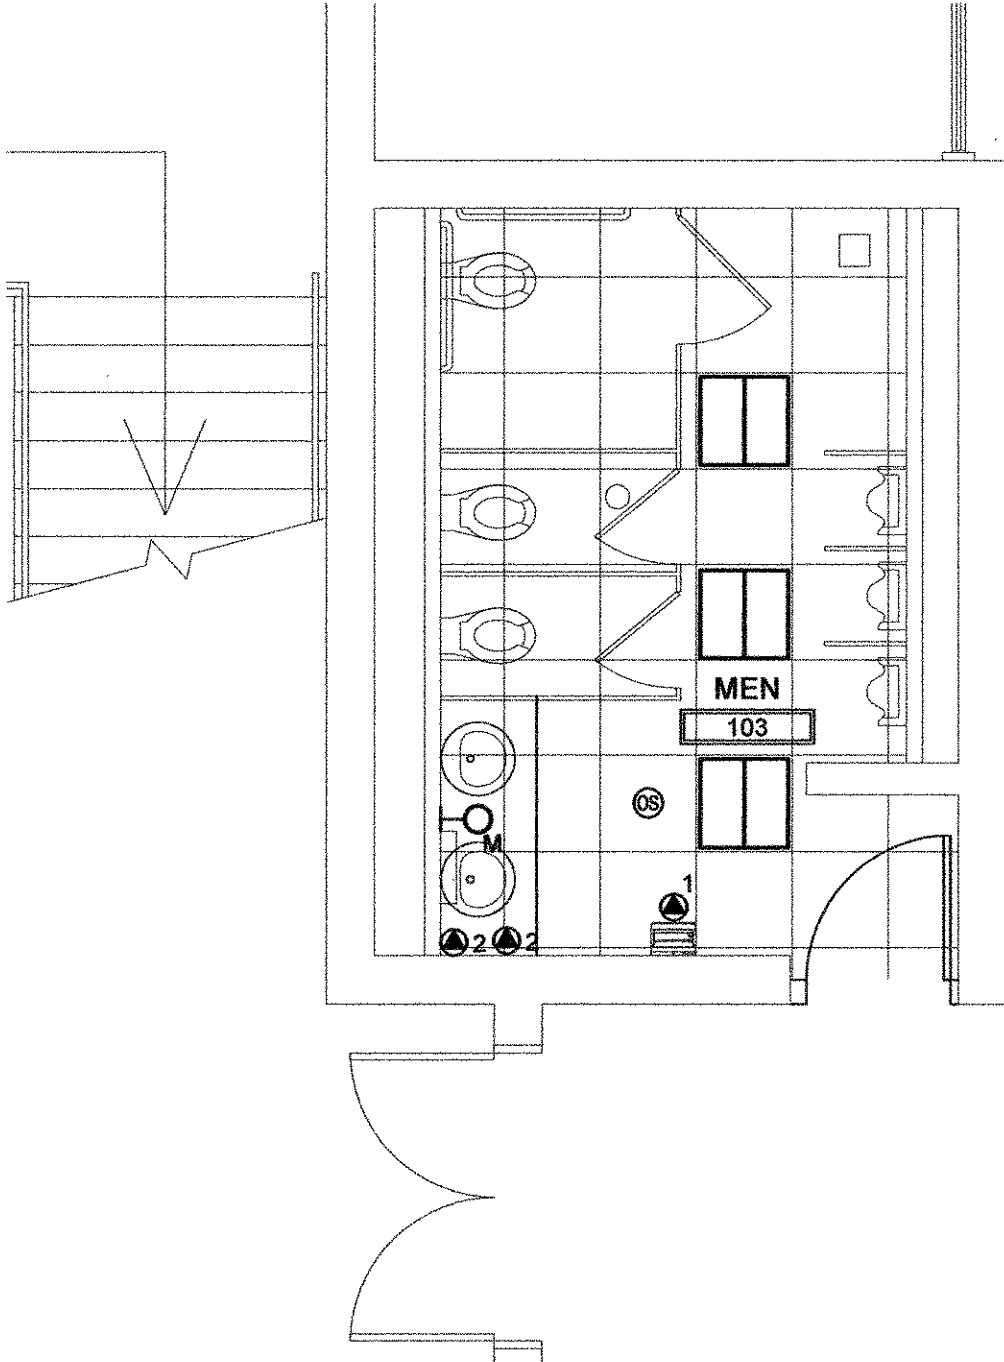



4 MEN'S TOILET - SOUTH
E101 SCALE: 1/4" = 1'-0"

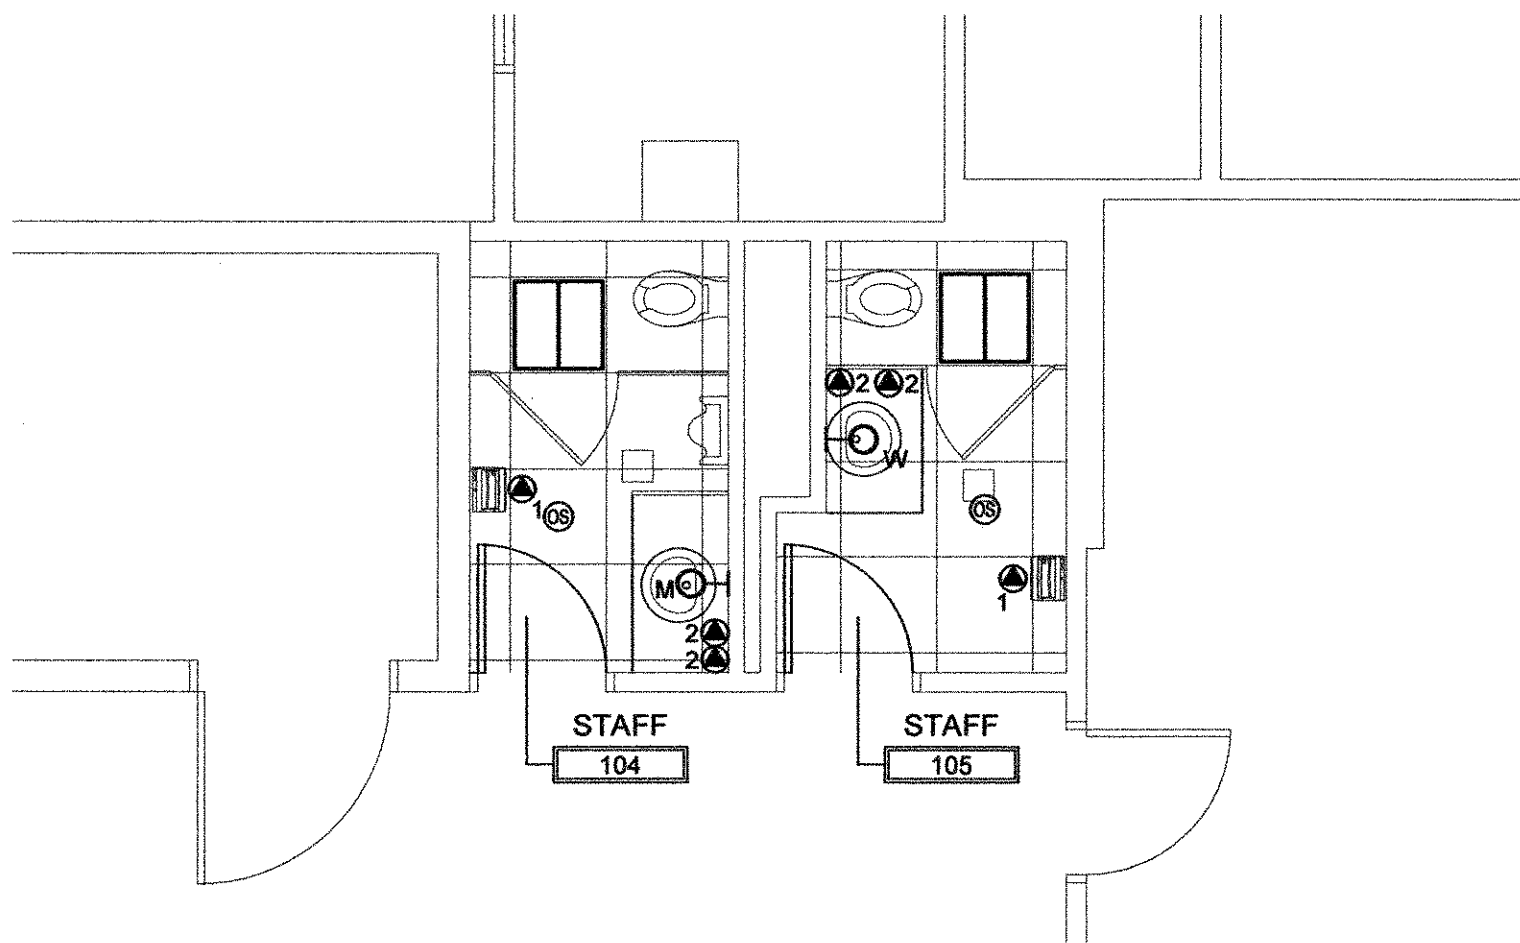


5 STAFF TOILET - SOUTH
E101 SCALE: 1/4" = 1'-0"

REV	DATE	BY	DESCRIPTION
0	4/22/2013	RBS	ISSUED FOR BID
REVISIONS			
DRAWN BY: MWH DATE: 08/08/2012 CHECKED BY: RBS DATE: 08/10/2012			


SCOPE OF WORK IN THIS CONTRACT SHALL INCLUDE FIRST FLOOR RESTROOM RENOVATIONS IN BASE BID.
PROVIDE ADD ALTERNATE #1 FOR SECOND FLOOR RESTROOM RENOVATIONS

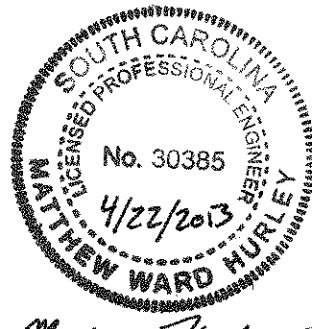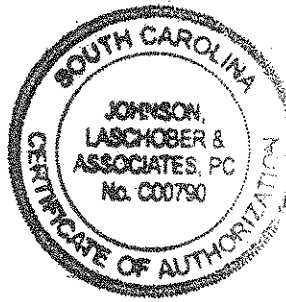


USC AIKEN AIKEN, SOUTH CAROLINA	
PENLAND BUILDING RESTROOM RENOVATIONS ELECTRICAL FIRST FLOOR PLAN	
JOHNSON, LASCHOB & ASSOCIATES, P.C. 1296 BROAD STREET AUGUSTA, GEORGIA 30901 TEL (706) 724-5756 FAX (706) 724-3955	
Architects • Engineers • Landscape Architects •	
SCALE 1/4"=1'-0"	DATE 8/8/2012
PROJECT NO. 6930.1202	DRAWING NO. E101
REV. 0	

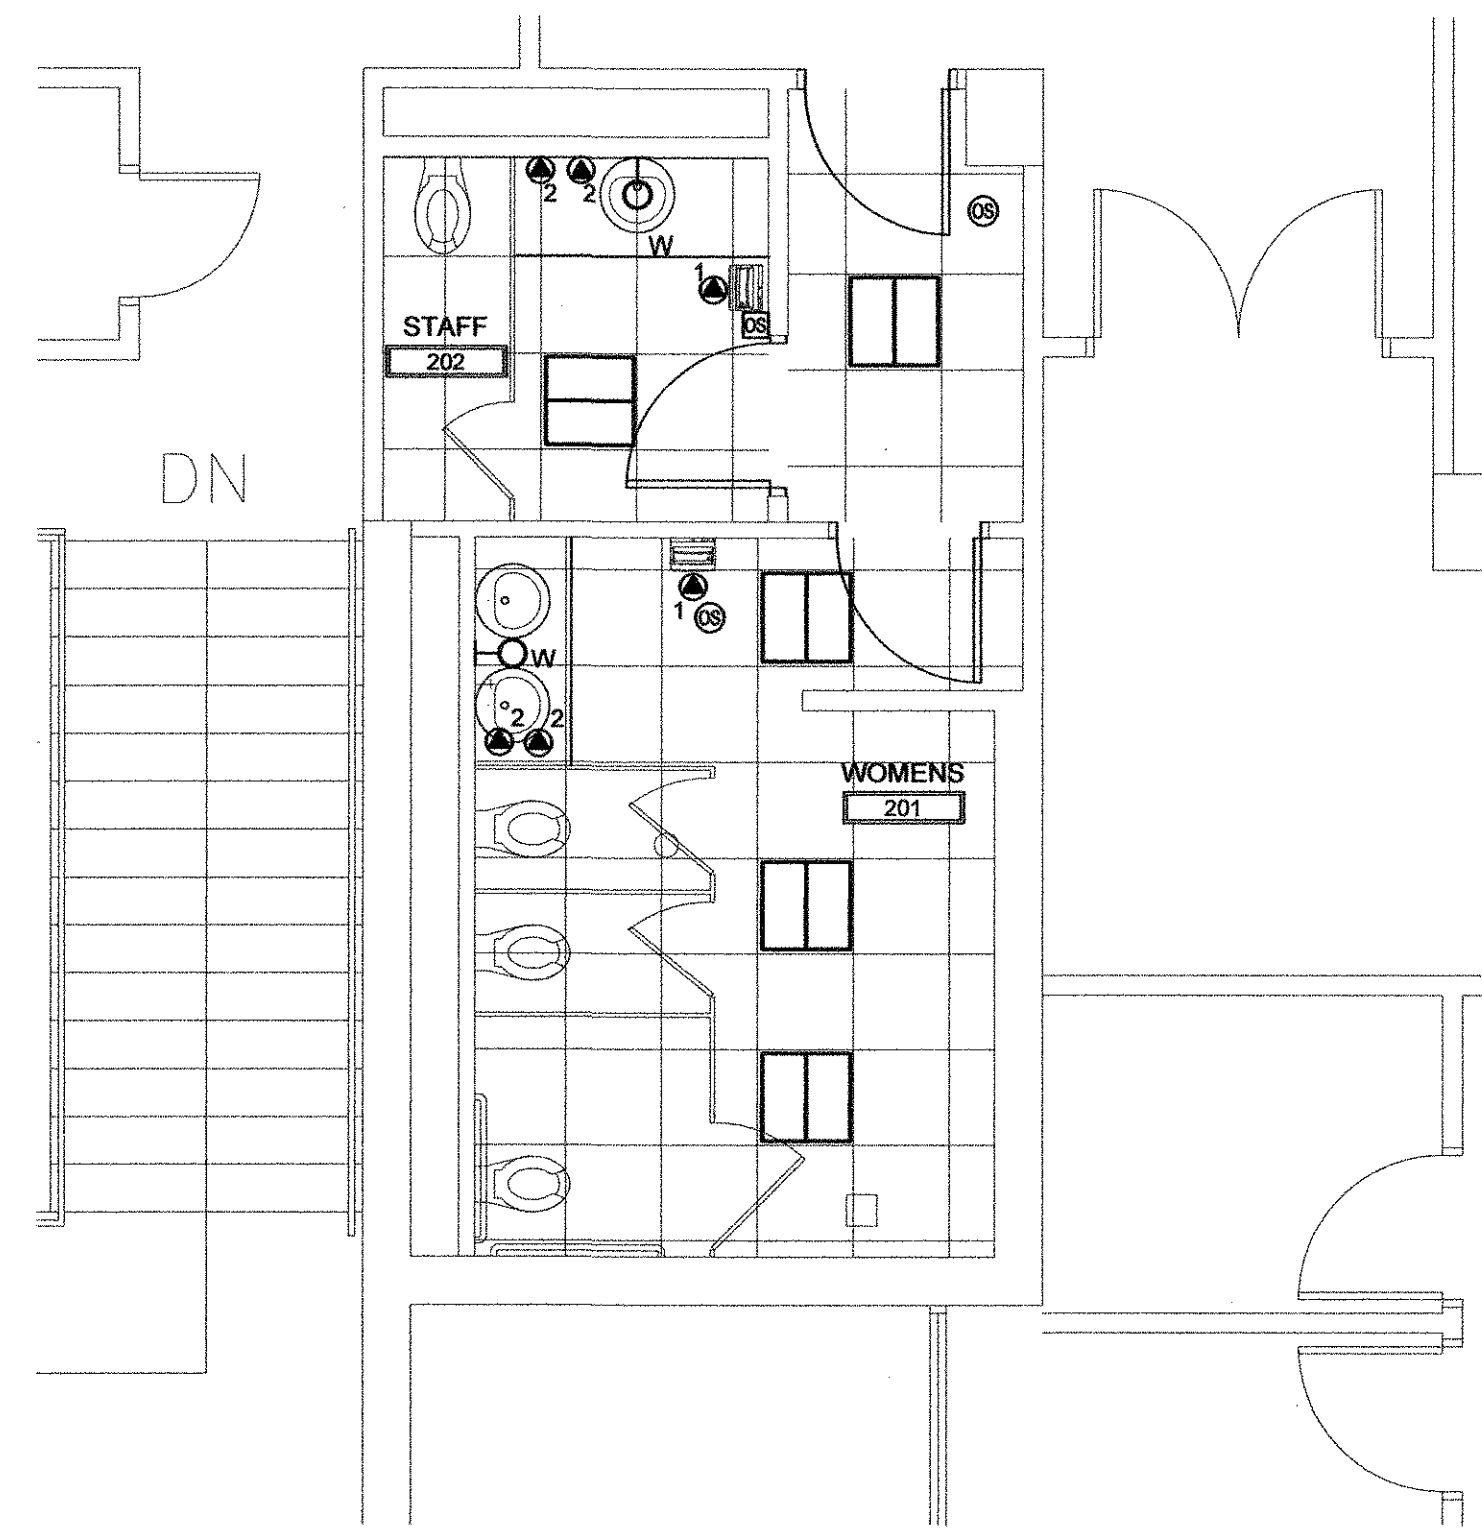


1 WOMEN'S TOILET - NORTH
E102 SCALE: 1/4" = 1'-0"

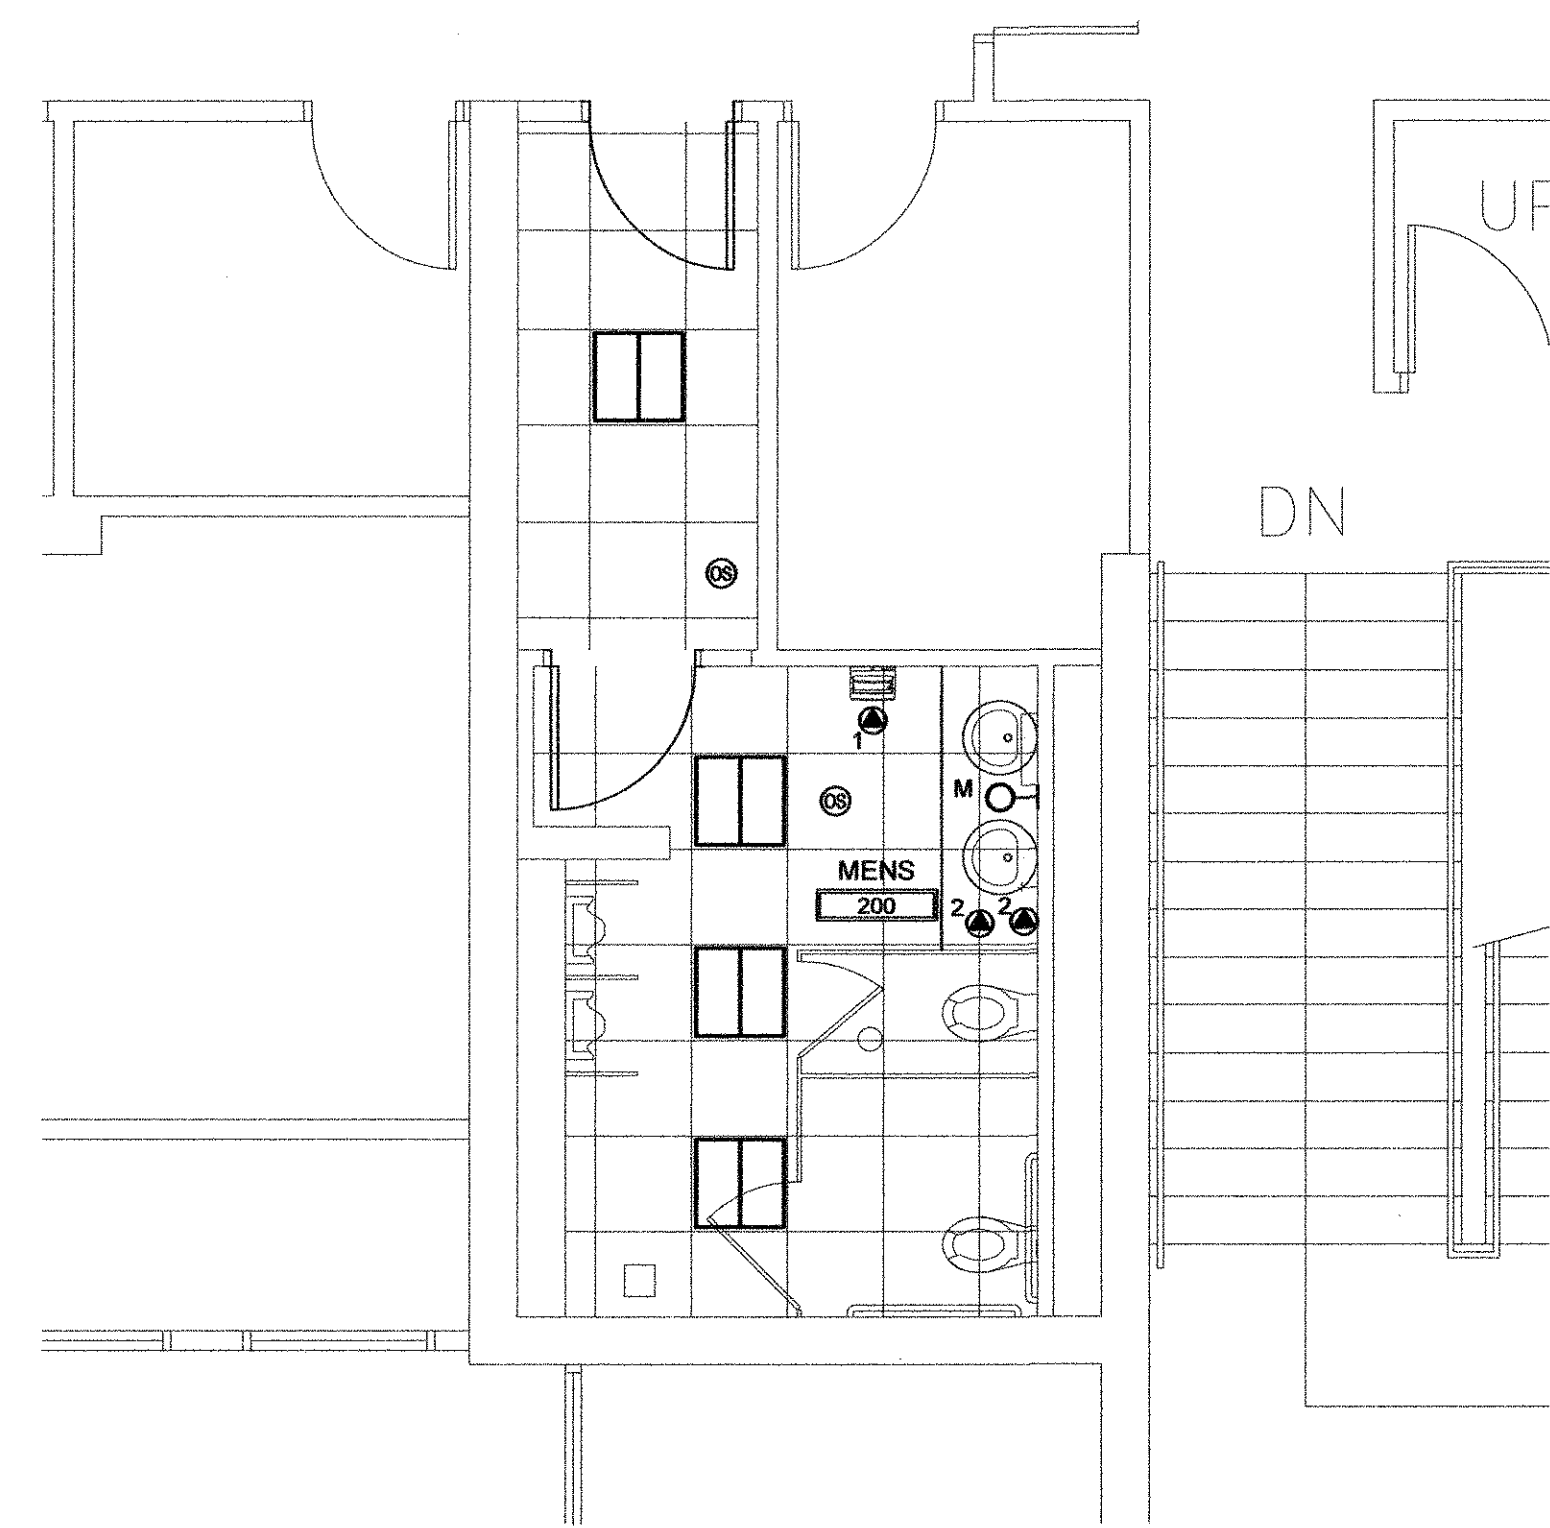

2 MEN'S TOILET - NORTH
E102 SCALE: 1/4" = 1'-0"

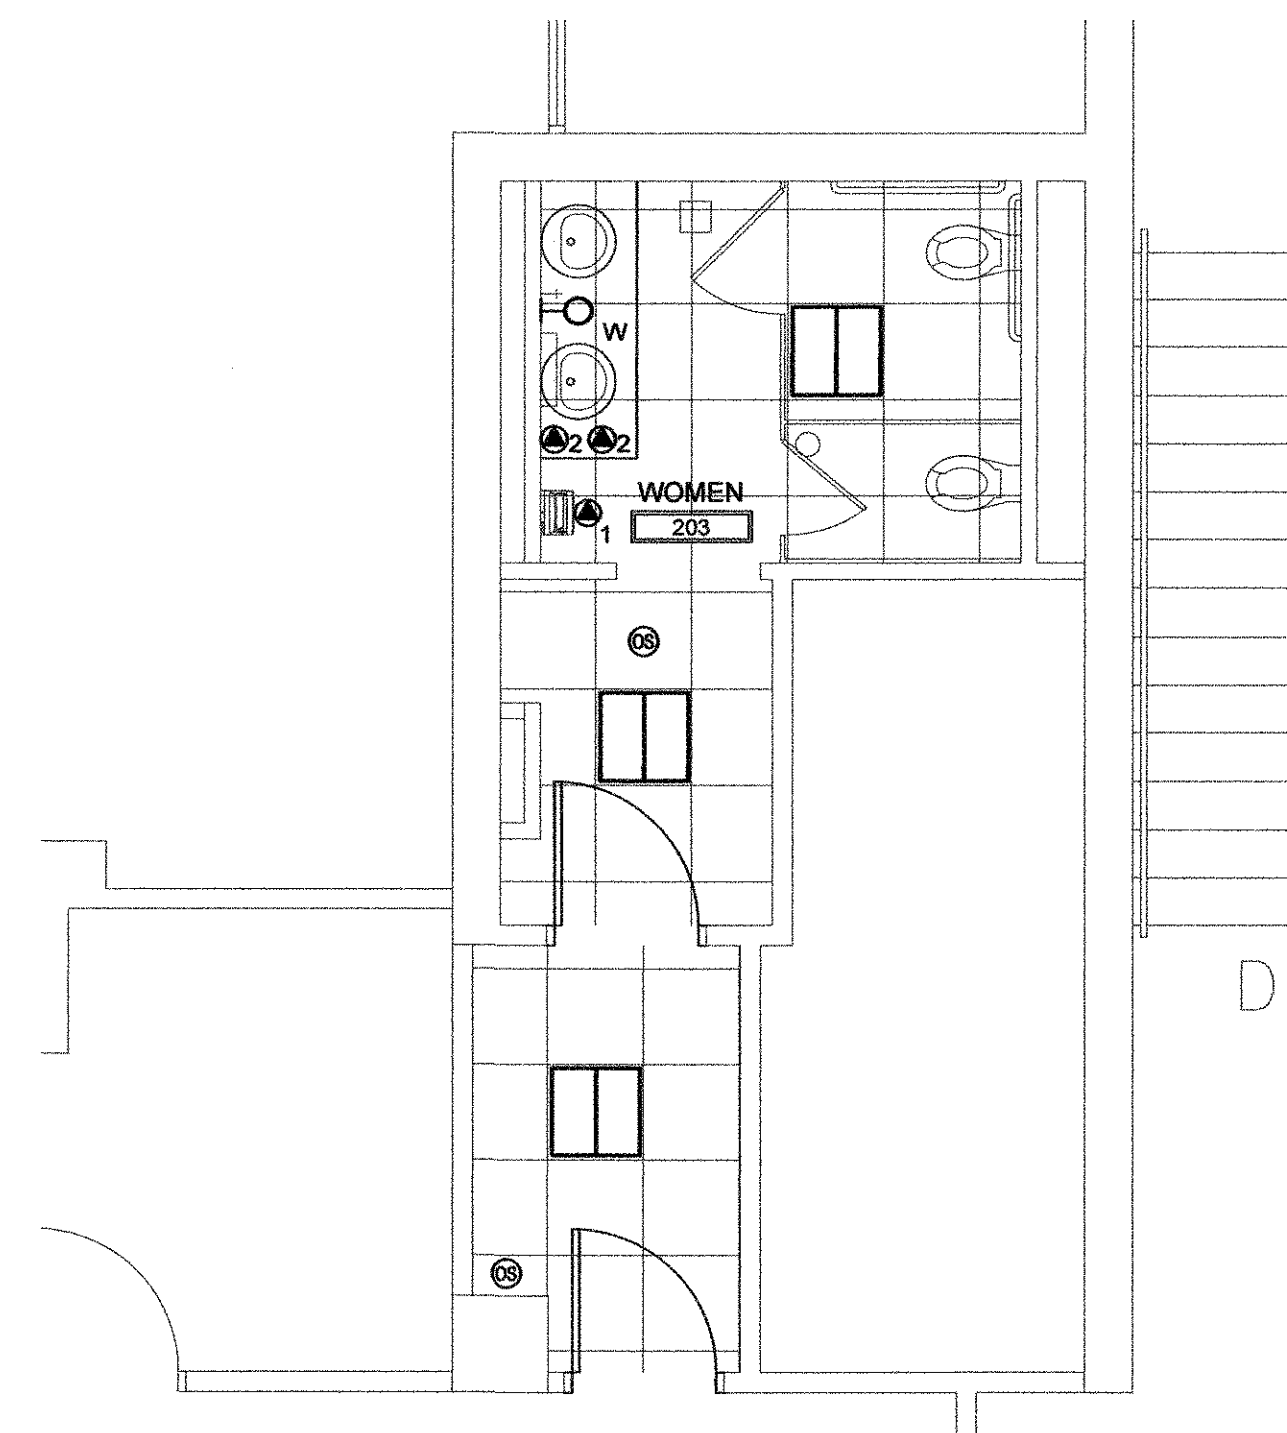



3 WOMEN'S TOILET - SOUTH
E102 SCALE: 1/4" = 1'-0"

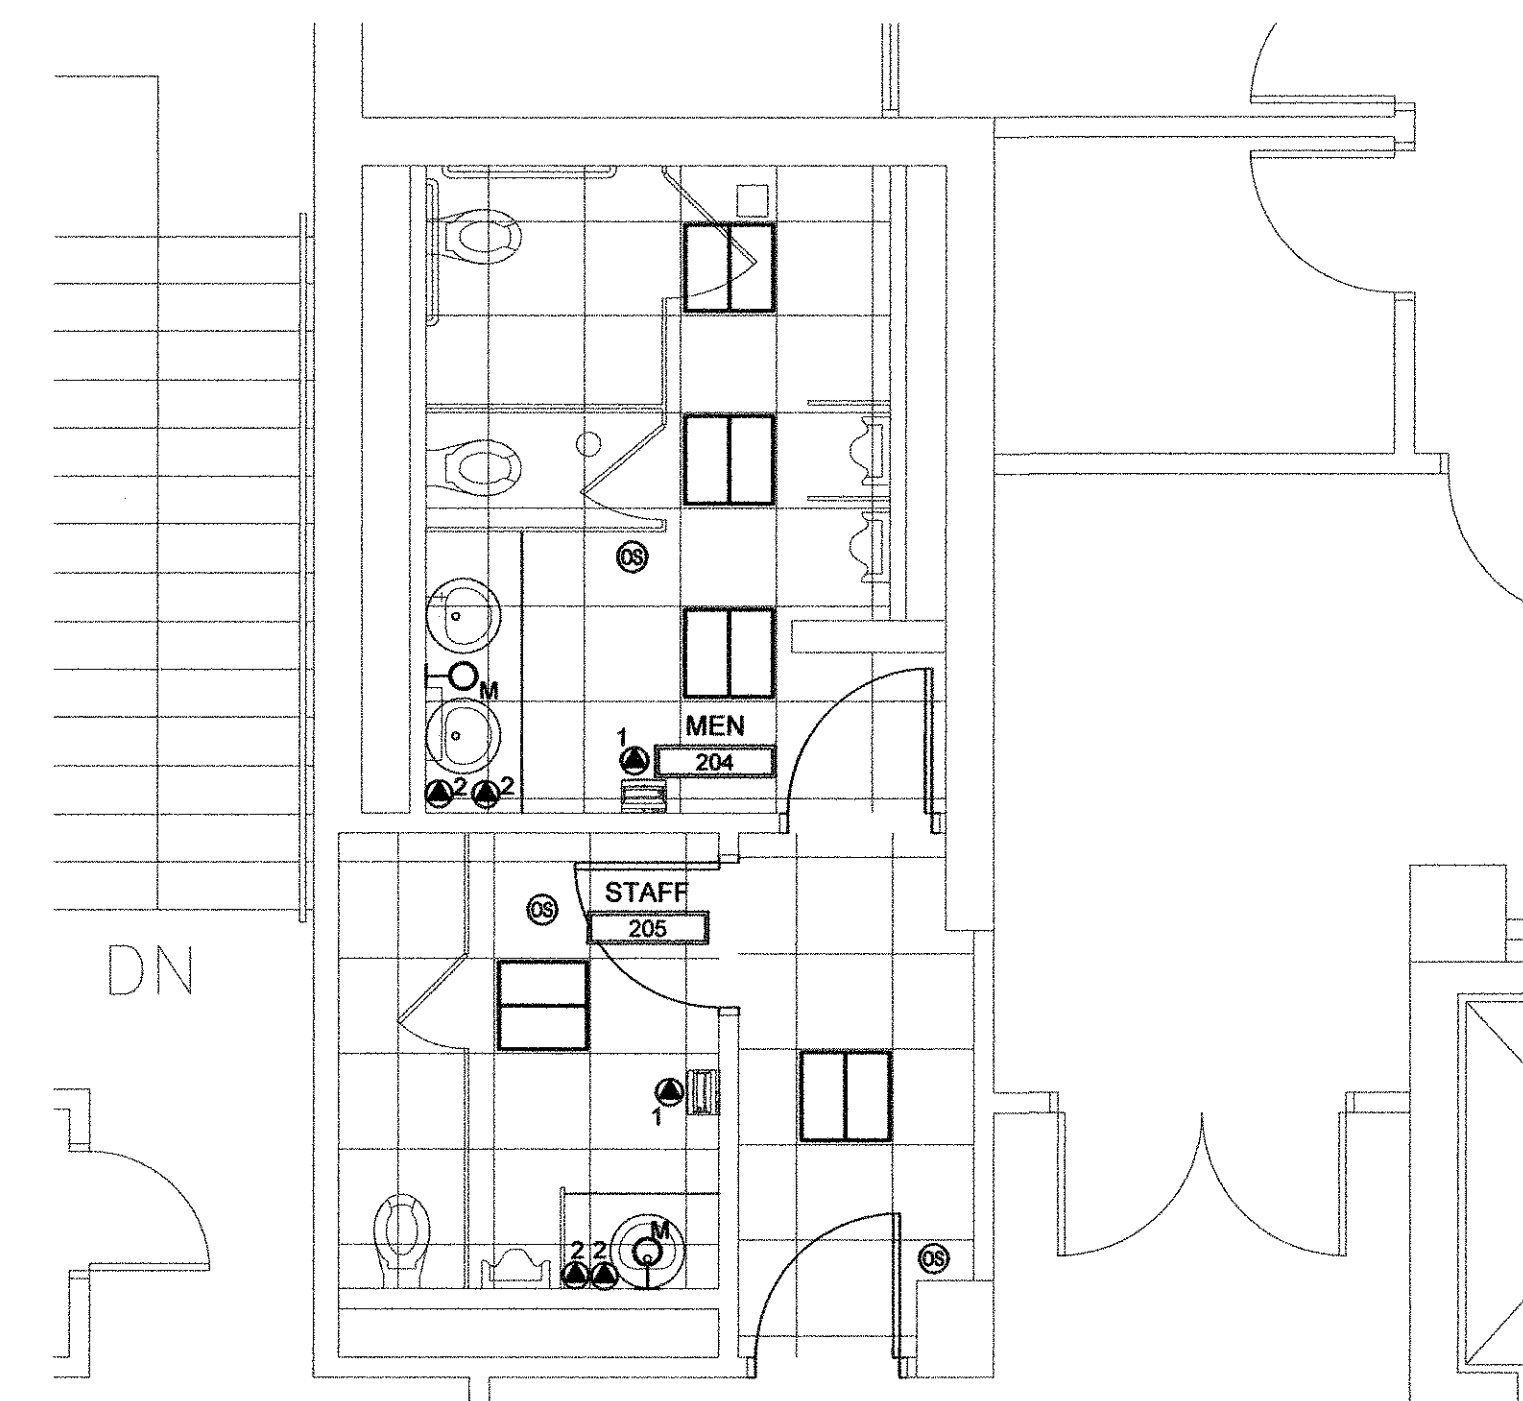

4 MEN'S TOILET - SOUTH
E102 SCALE: 1/4" = 1'-0"

REV	DATE	BY	DESCRIPTION
0	4/22/2013	RBS	ISSUED FOR BID
REVISIONS			
DRAWN BY: MWH DATE: 08/08/2012 CHECKED BY: RBS DATE: 08/10/2012			

SCOPE OF WORK IN THIS CONTRACT SHALL INCLUDE FIRST FLOOR
RESTROOM RENOVATIONS IN BASE BID.
PROVIDE ADD ALTERNATE #1 FOR SECOND FLOOR RESTROOM
RENOVATIONS

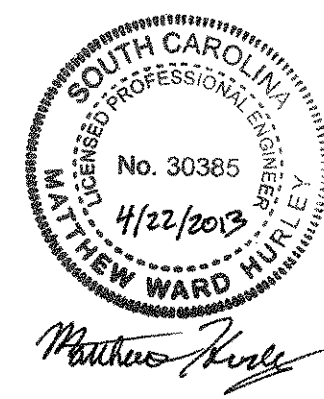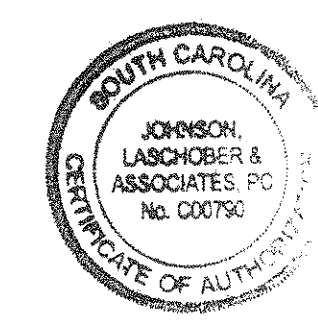

USC AIKEN AIKEN, SOUTH CAROLINA			
PENLAND BUILDING RESTROOM RENOVATIONS			
ELECTRICAL SECOND FLOOR PLAN			
JOHNSON, LASCHOBER & ASSOCIATES, P.C.			
1296 BROAD STREET TEL (706) 724-5756		AUGUSTA, GEORGIA 30901 FAX (706) 724-3955	
SCALE 1/4"=1'-0"	DATE 8/8/2012	PROJECT NO. 6930.1202	DRAWING NO. E102
			REV. 0